

Thursday, January 26, 2023

PLEASE MUTE YOUR MICROPHONE

Julie Trott, Commission Chair Daniel A. Musson, Secretary


Preamble

IN COMPLIANCE WITH NOTIFICATION REQUIREMENTS OF OHIO'S OPEN MEETING LAW AND SECTION 101.021 OF THE CODIFIED ORDINANCES OF CLEVELAND, OHIO, 1976, NOTICE OF THIS MEETING HAS BEEN PUBLICLY POSTED.

ALL BOARDS AND COMMISSIONS UNDER THE PURVIEW OF THE CITY PLANNING DEPARTMENT CONDUCTS ITS MEETINGS ACCORDING TO ROBERT'S RULES OF ORDER. ACTIONS DURING THE MEETING WILL BE TAKEN BY VOICE VOTE. ABSTENTIONS FROM ANY VOTE DUE TO A CONFLICT OF INTEREST SHOULD BE STATED FOR THE RECORD PRIOR TO THE TAKING OF ANY VOTE.

IN ORDER TO ENSURE THAT EVERYONE PARTICIPATING IN THE MEETING HAS THE OPPORTUNITY TO BE HEARD, WE ASK THAT YOU USE THE RAISE HAND FEATURE BEFORE ASKING A QUESTION OR MAKING A COMMENT. THE RAISE HAND FEATURE CAN BE FOUND IN THE PARTICIPANTS PANEL ON THE DESKTOP AND MOBILE VERSION AND ACTIVATED BY CLICKING THE HAND ICON. PLEASE WAIT FOR THE CHAIR OR FACILITATOR TO RECOGNIZE YOU AND BE SURE TO SELECT UNMUTE AND ANNOUNCE YOURSELF BEFORE YOU SPEAK. WHEN FINISHED SPEAKING, PLEASE LOWER YOUR HAND BY CLICKING ON THE RAISE HAND ICON AGAIN AND MUTE YOUR MICROPHONE.

WE WILL ALSO BE UTILIZING THE CHAT FEATURE TO COMMUNICATE WITH PARTICIPANTS. THE CHAT FEATURE CAN BE ACTIVATED BY CLICKING THE CHAT BUTTON LOCATED ON THE BOTTOM OF THE WEBEX SCREEN.

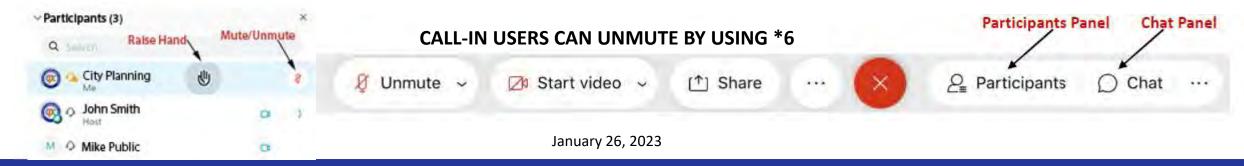


Preamble

ALL MEETING ACTIVITY IS BEING RECORDED VIA THE WEBEX PLATFORM.

THESE PROCEEDINGS ARE ALSO BEING LIVE STREAMED VIA YOUTUBE.

ALL REQUESTS TO SPEAK ON A PARTICULAR MATTER VIA OUR WEBSITE AND EMAIL HAVE BEEN CONSIDERED.

WE HAVE ALSO RECEIVED EMAILS FROM THOSE WHO HAVE PROVIDED WRITTEN COMMENT ON A PARTICULAR MATTER.

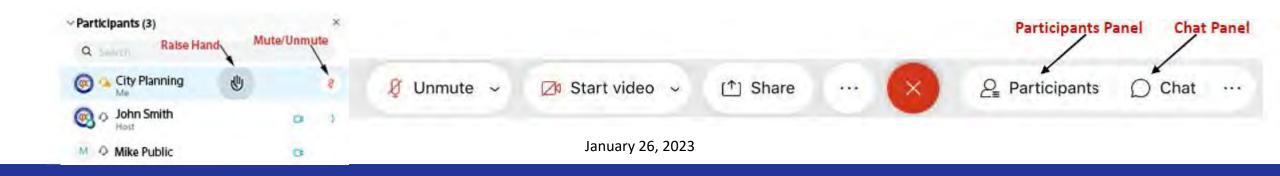

Call to Order & Roll Call



January 26, 2023



- Each project is considered on a case-by-case basis.
- The Chair will call each agenda item and then each applicant will be invited to proceed through their presentation.
- Each presentation should be completed prior to questions and comments from the Commission, in order to facilitate a smooth presentation.
- Once the presentation has concluded, the Chair will ask Landmarks staff to summarize Design Review Committee
 recommendations and any public comments received: The deadline for public comments is noon on the Tuesday
 prior to any regularly scheduled Cleveland Landmarks Commission meeting. Any received comments are distributed
 to Commission members prior to the meeting. Staff will also identify any members of the public present and
 scheduled to speak.
- Public comment is allowed at the discretion of the Chair and any individual providing public comment is permitted two (2) minutes to speak to the agenda item in which they have an interest.
- The Chair will then request a recommendation from staff.
- The Commission will then begin deliberations and project review.
- Any Commission member, except the Chair, may make a motion at any point after an agenda item has been called.

Certificates of Appropriateness



Certificate of Appropriateness

January 26, 2023



Case 23-004: Market Square Historic District

2011 West 25th Street

ATM Installation and Signage


Ward 3: McCormack


Project Representatives: Ben Gingrich, Mickey Petrucz (HSB Architects)


ReyBank Om

NEW WALK UP ATM KIOSK

WEST 25TH STREET & LORAIN AVE

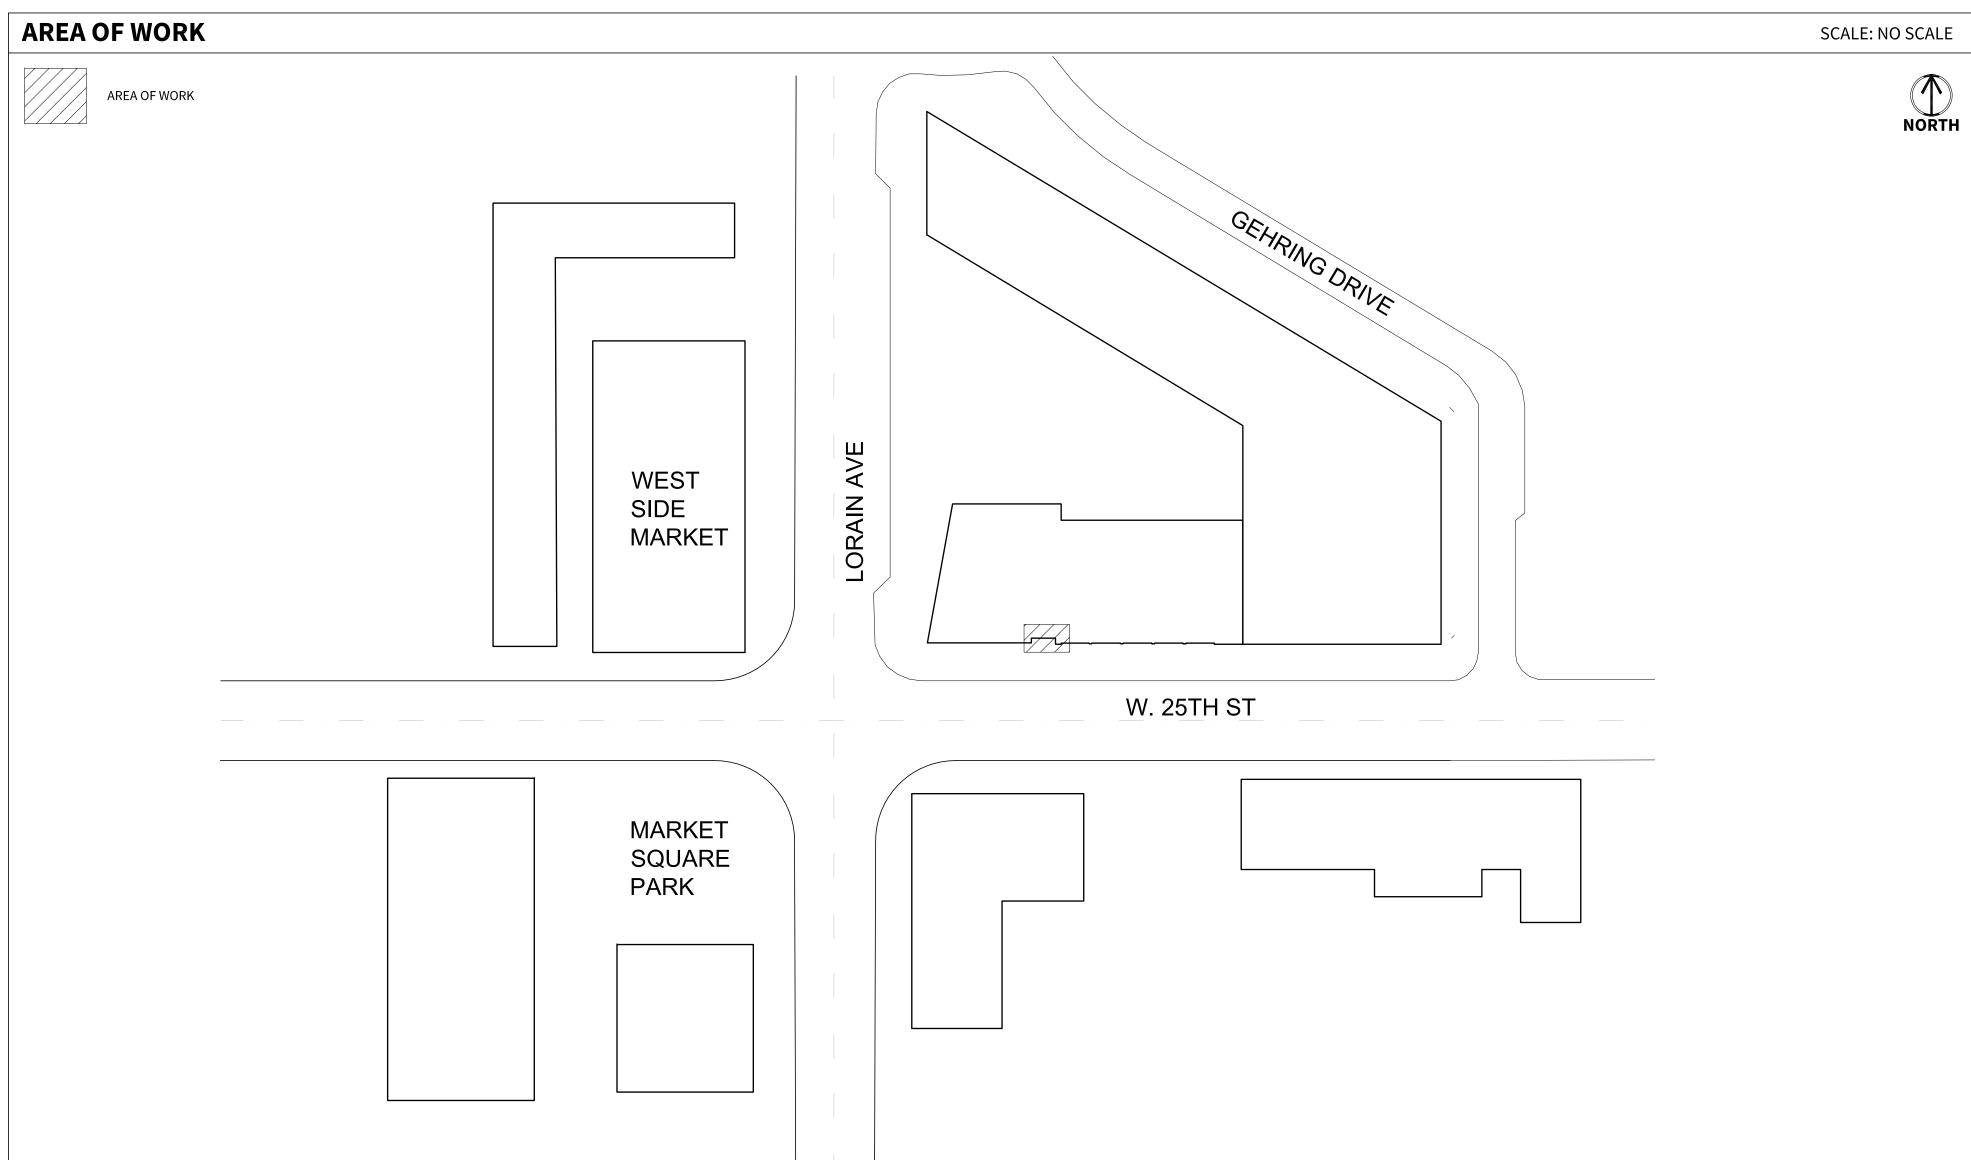

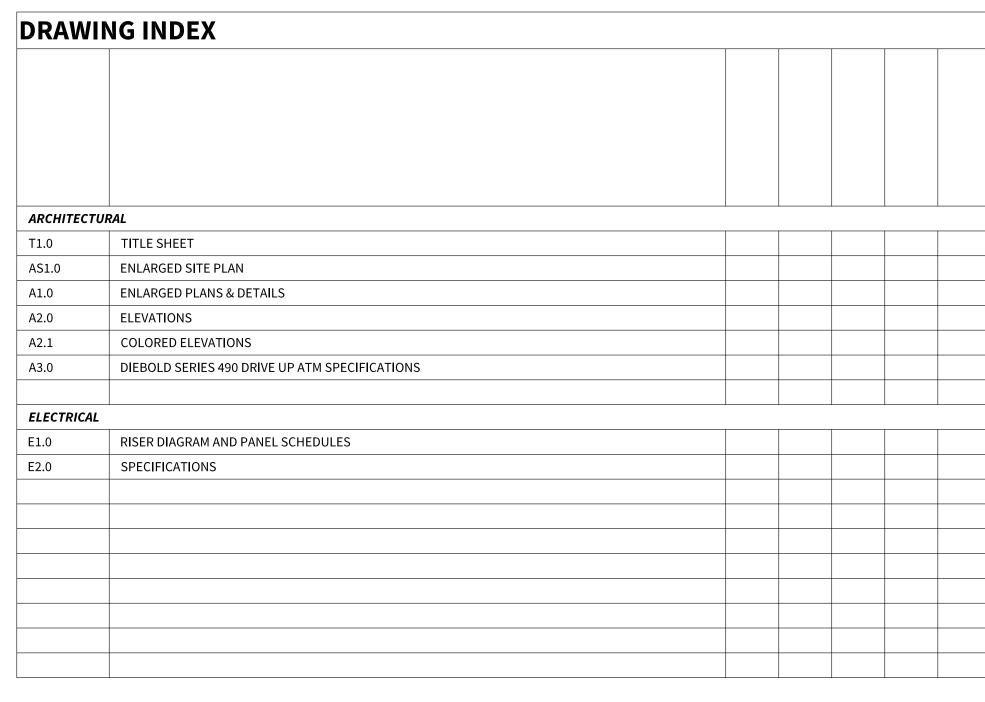


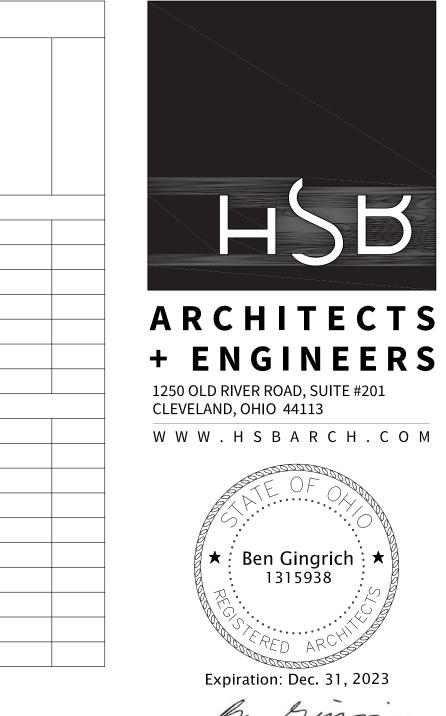



			NO
PROJECT LOCATION —	/		
PROJECT DESCRIPTIONS	S		


PROJECT CONTACT	ARCHITECT	ENGINEER
MICKEY PETRUCZ HSB ARCHITECTS + ENGINEERS 1250 OLD RIVER RD CLEVELAND OH,44113 MPETRUCZ@HSBARCH.COM 216-470-4134	BEN GINGRICH HSB ARCHITECTS + ENGINEERS 1250 OLD RIVER RD CLEVELAND OH,44113 BGINGRICH@HSBARCH.COM 216-325-1351	PETER KAMIS HSB ARCHITECTS + ENGINEERS 1250 OLD RIVER RD CLEVELAND OH,44113 PKAMIS@HSBARCH.COM 216-325-0575
OWNER		
BRUCE DANKO KEYBANK 127 PUBLIC SQUARE CLEVELAND OH, 44114 BRUCE_F_DANKO@KEYBANK.COM 216-471-2571		

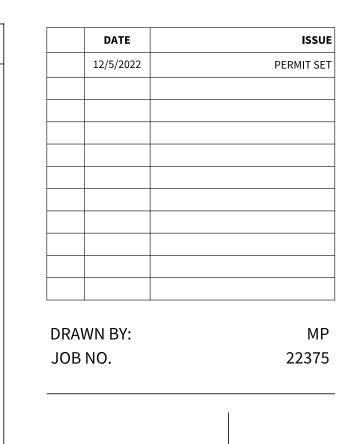


KEYBANK DRIVE-UP ATM NEW WALK-UP ATM & CANOPY

TITLE SHEET


T1.0

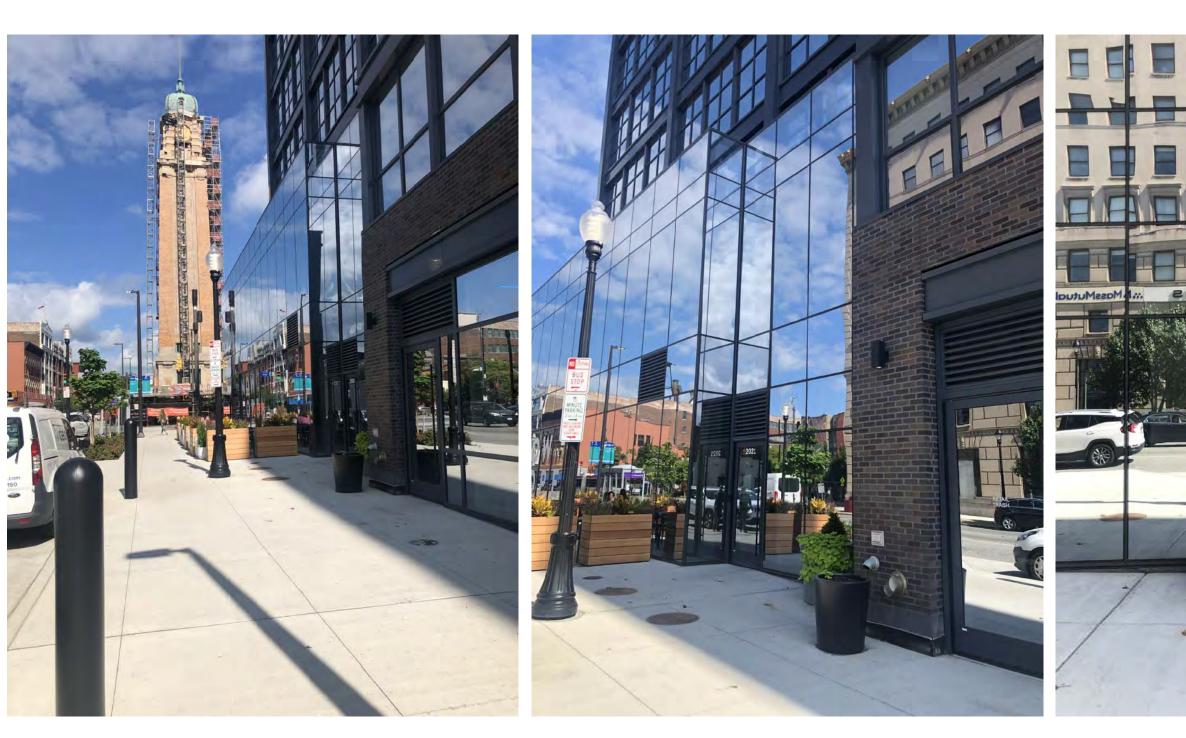

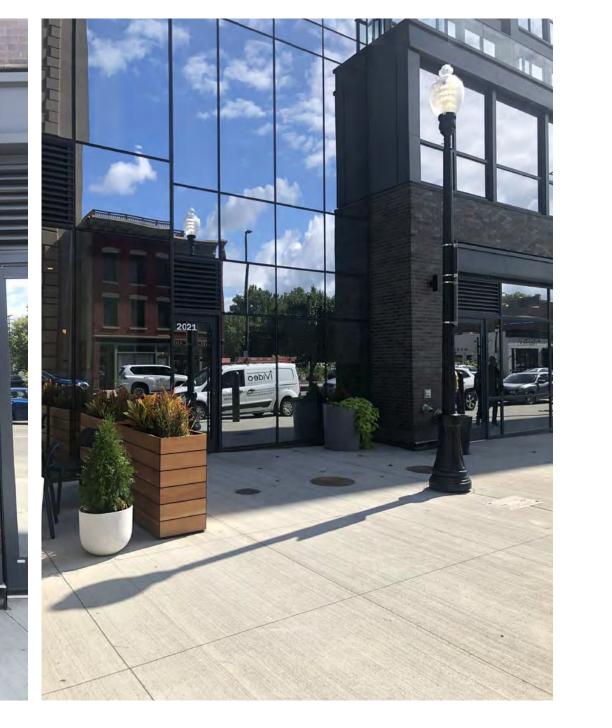



SAWCUT AND REMOVE PORTION OF EXISTING SLAB FOR NEW ATM PAD.

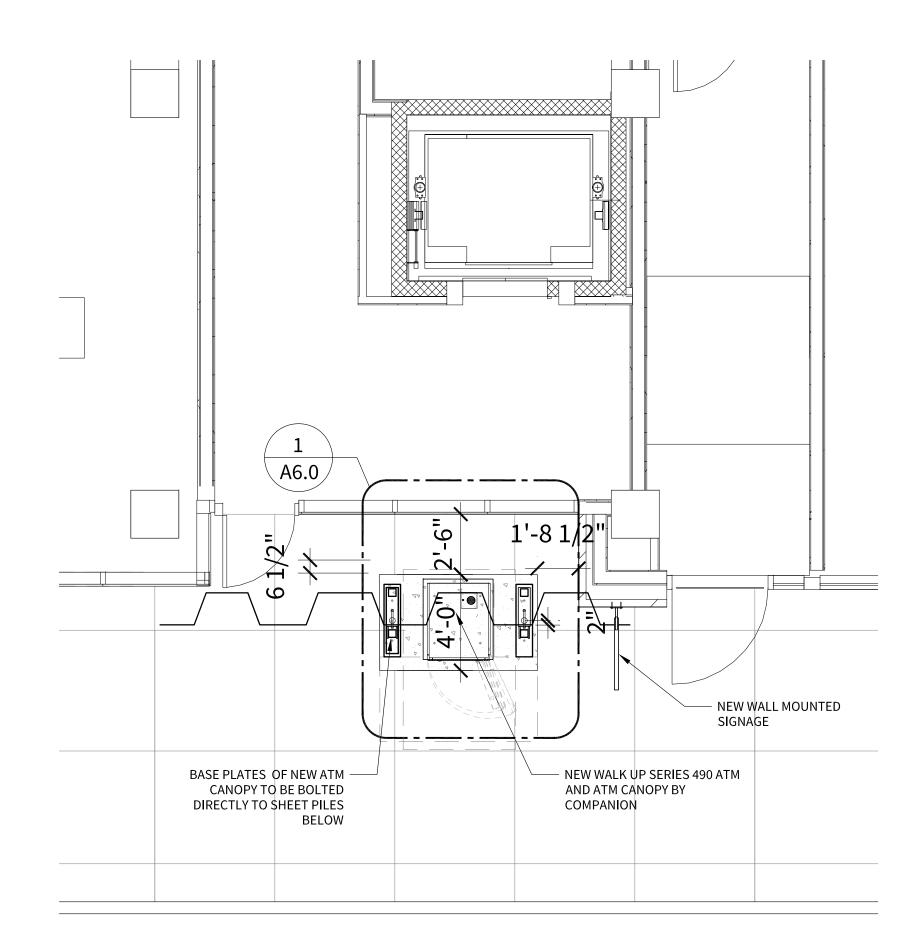

 DEMOPLAN
 1

 SCALE: 1/4" = 1'-0"
 A1.0

ATM PLAN 2
SCALE: 1/4" = 1'-0" A1.0



ARCHITECTS + ENGINEERS

1250 OLD RIVER ROAD, SUITE #201 CLEVELAND, OHIO 44113

W W W . H S B A R C H . C O M

★ Ben Gingrich ★ 1315938

Expiration: Dec. 31, 2023

DATE ISSUE
12/5/2022 PERMIT SET

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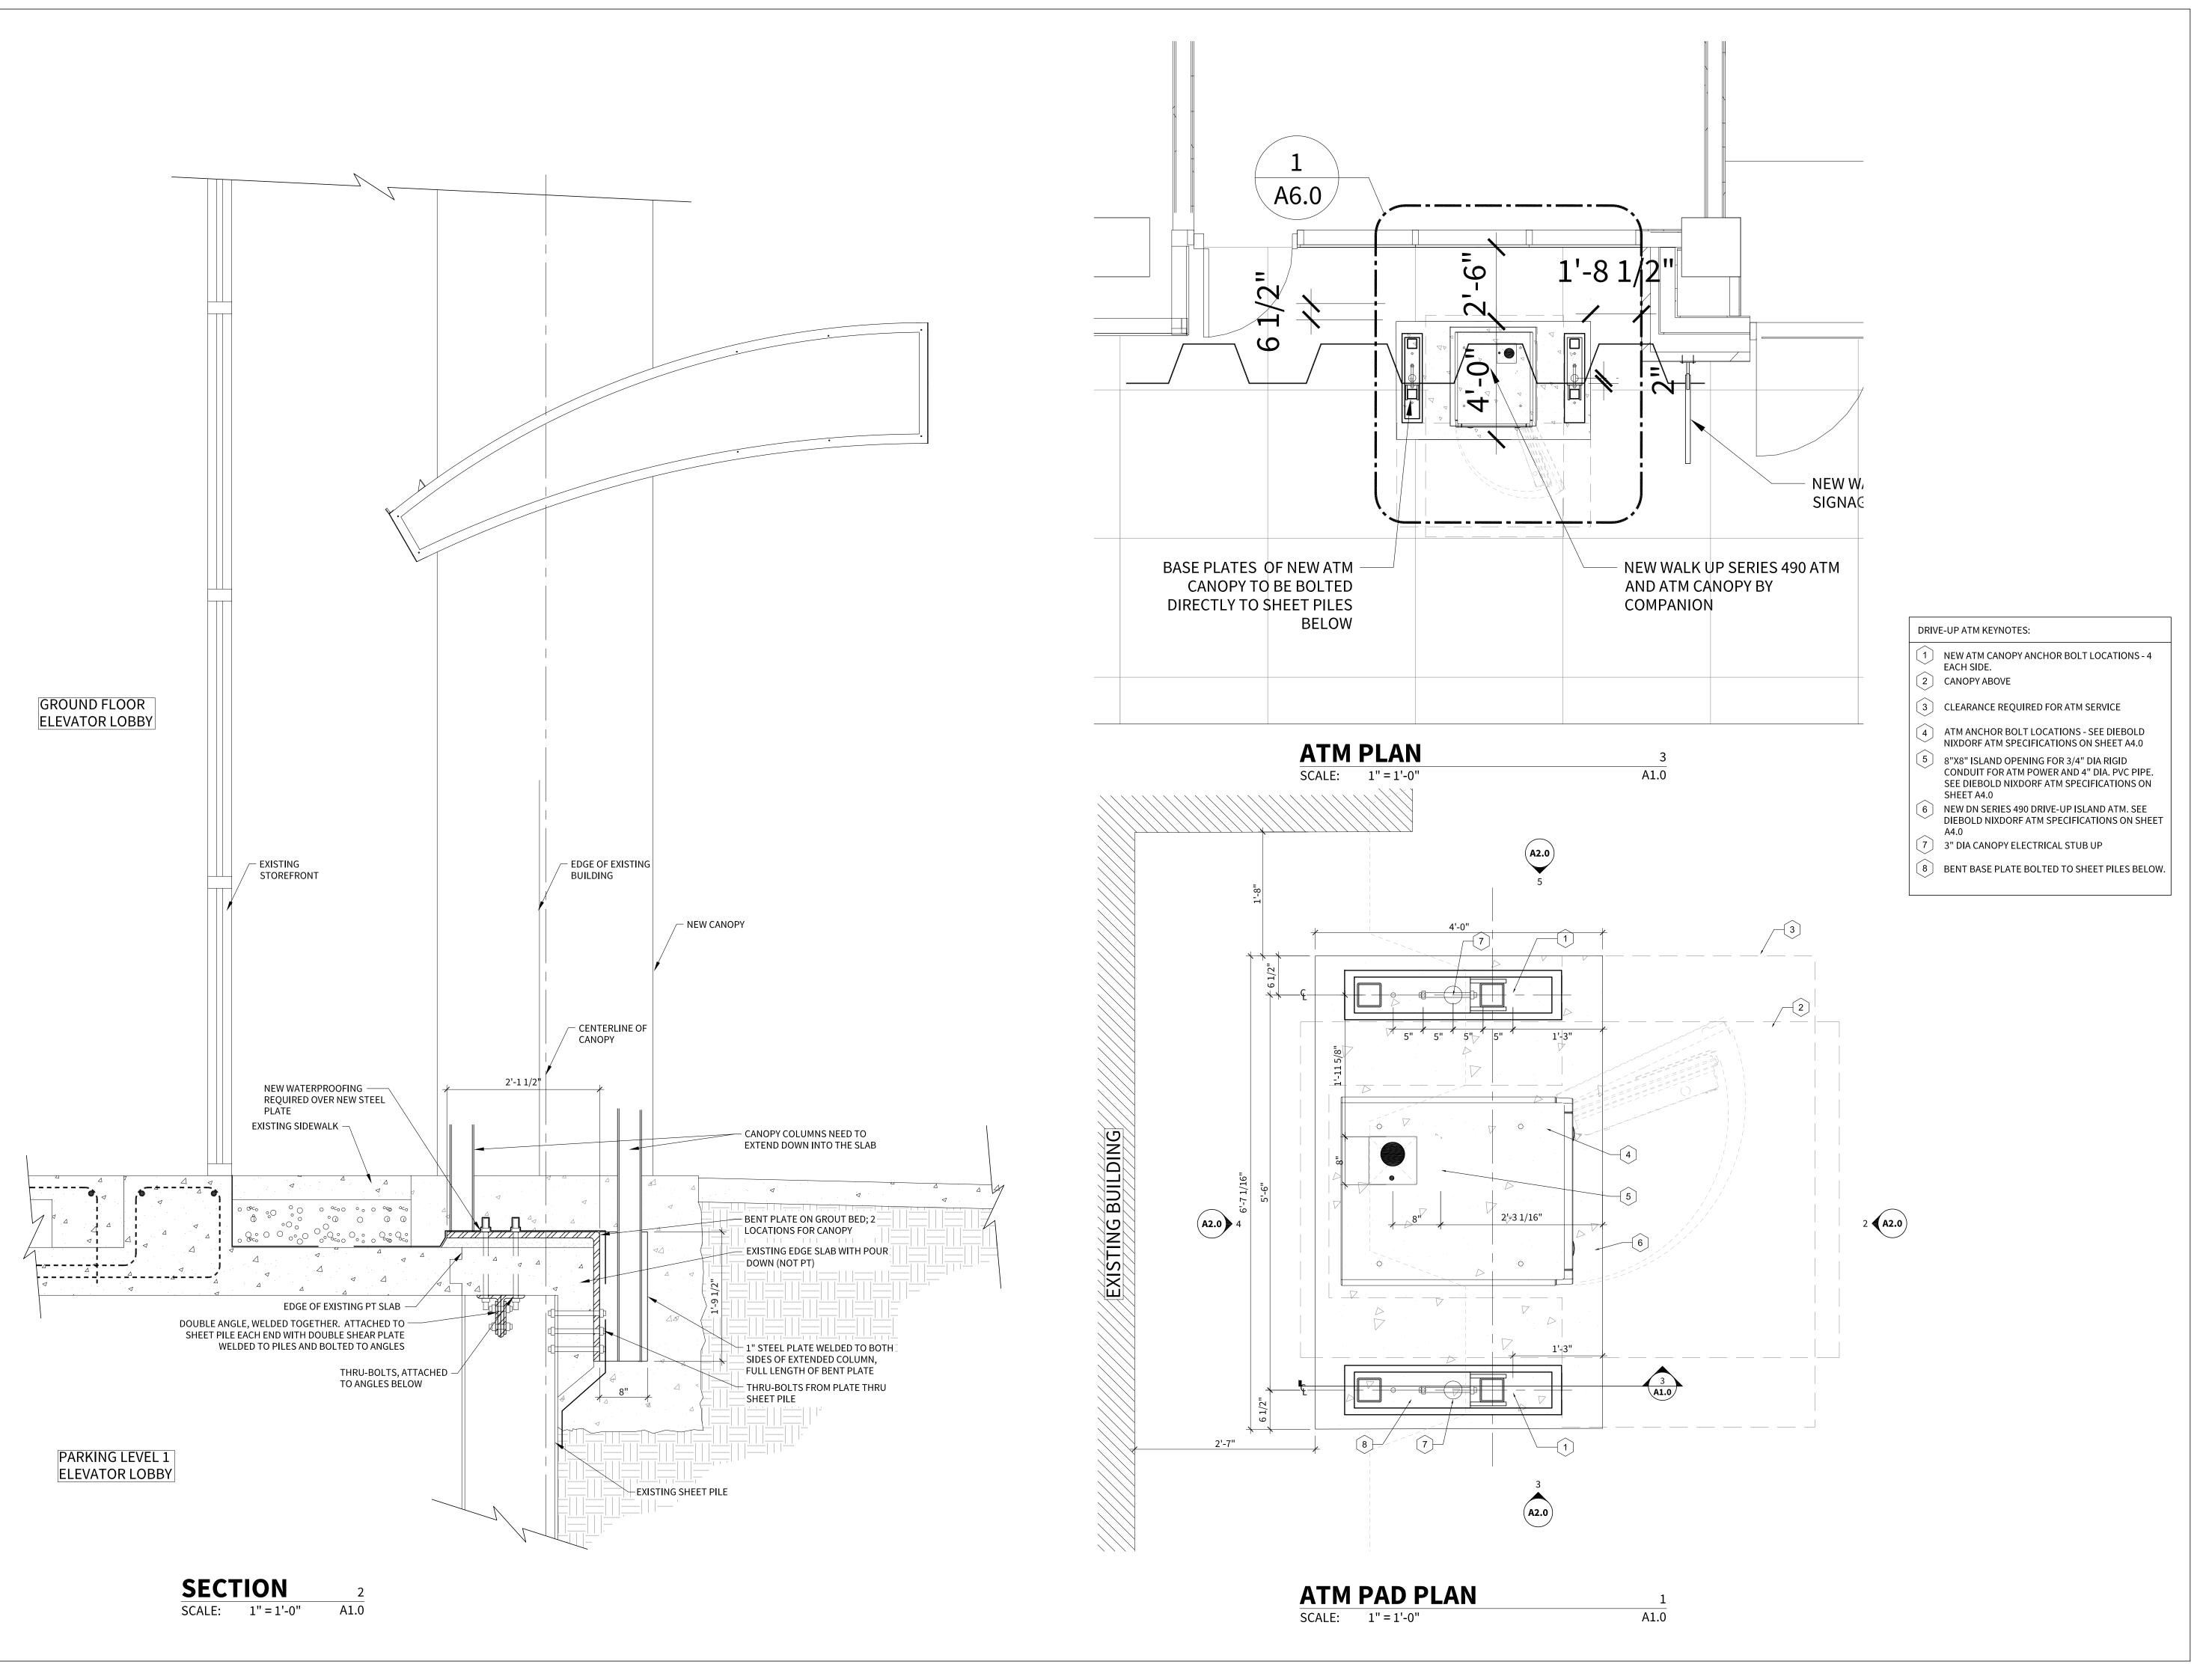
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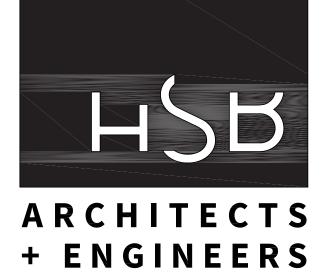
IK DRIVE-UP ATM 6-UP ATM & CANOPY

.011 W 25TH ST, LEVELAND, OH 44113

ENLARGED SITE PLAN

AS1.0





1250 OLD RIVER ROAD, SUITE #201 CLEVELAND, OHIO 44113 W W W . H S B A R C H . C O M



ISSUE	DATE
PERMIT SET	12/5/2022


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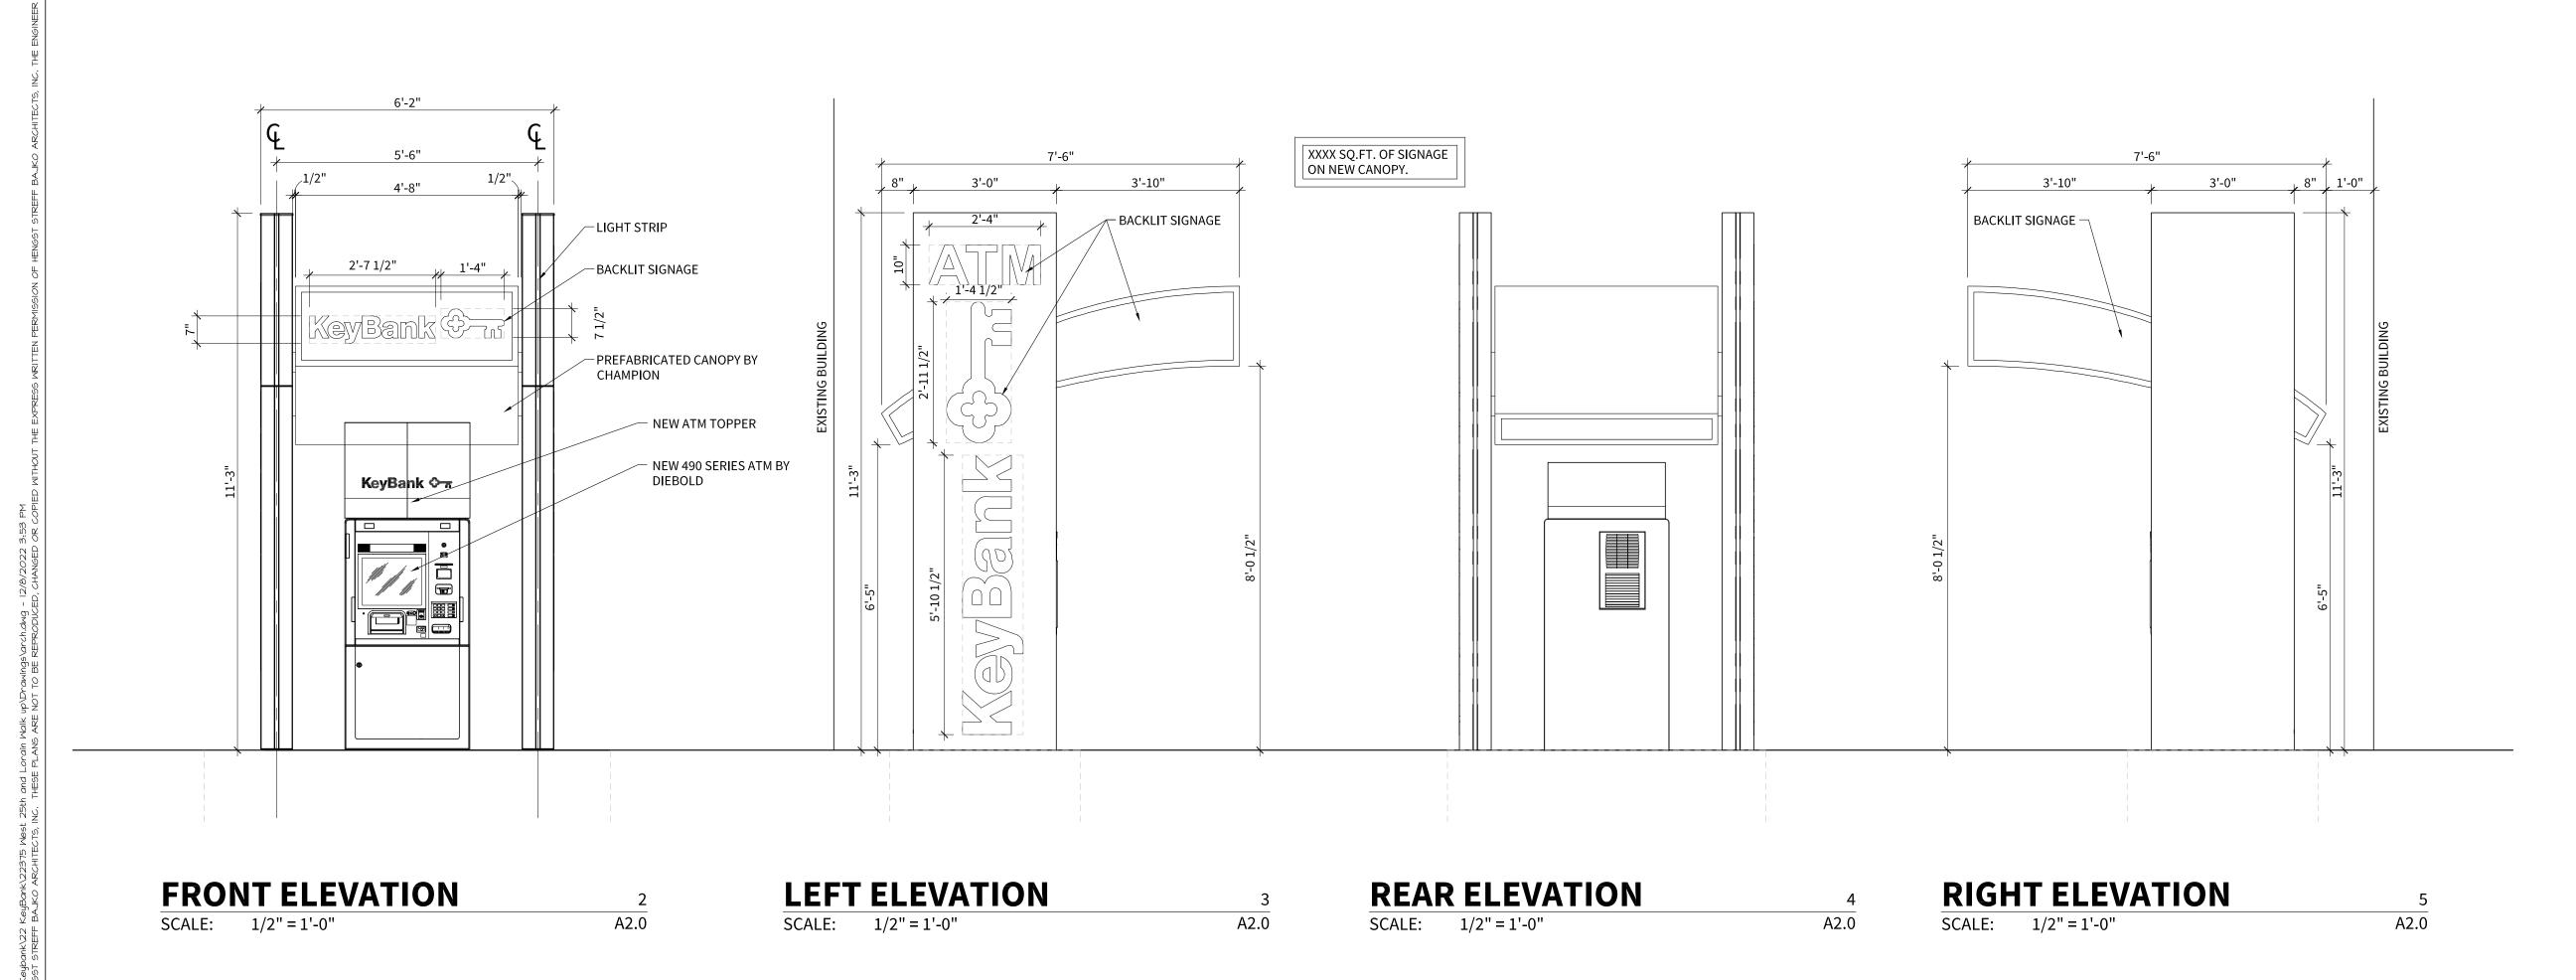
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ENLARGED PLANS AND ELEVATIONS







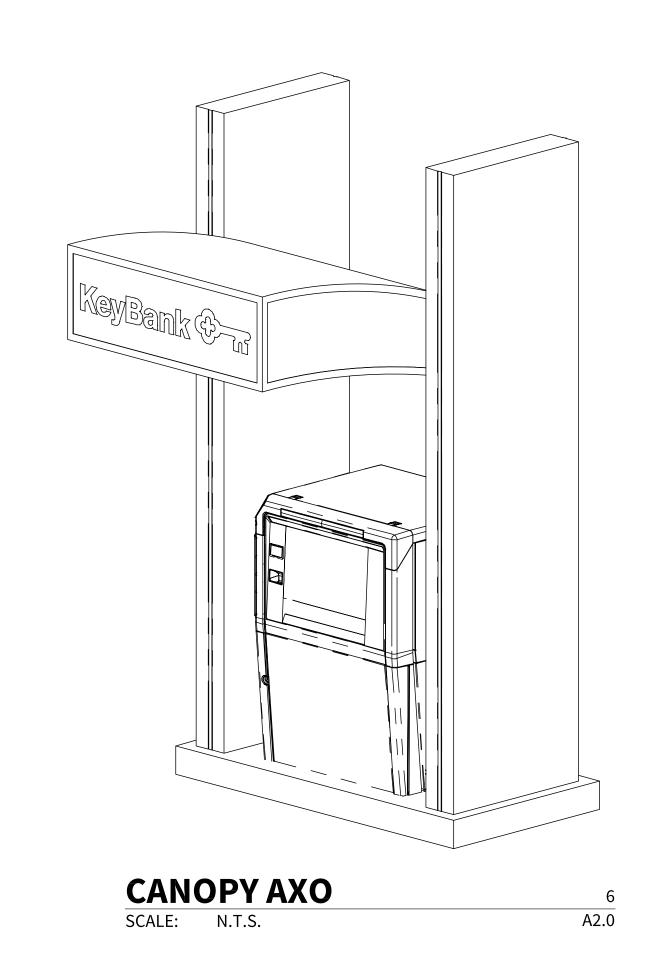

ISSUE	DATE	
PERMIT SET	12/5/2022	

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EYBANK DRIVE-UP ATM EW CANOPY CAND OF A CAND O

ELEVATIONS

A2.0






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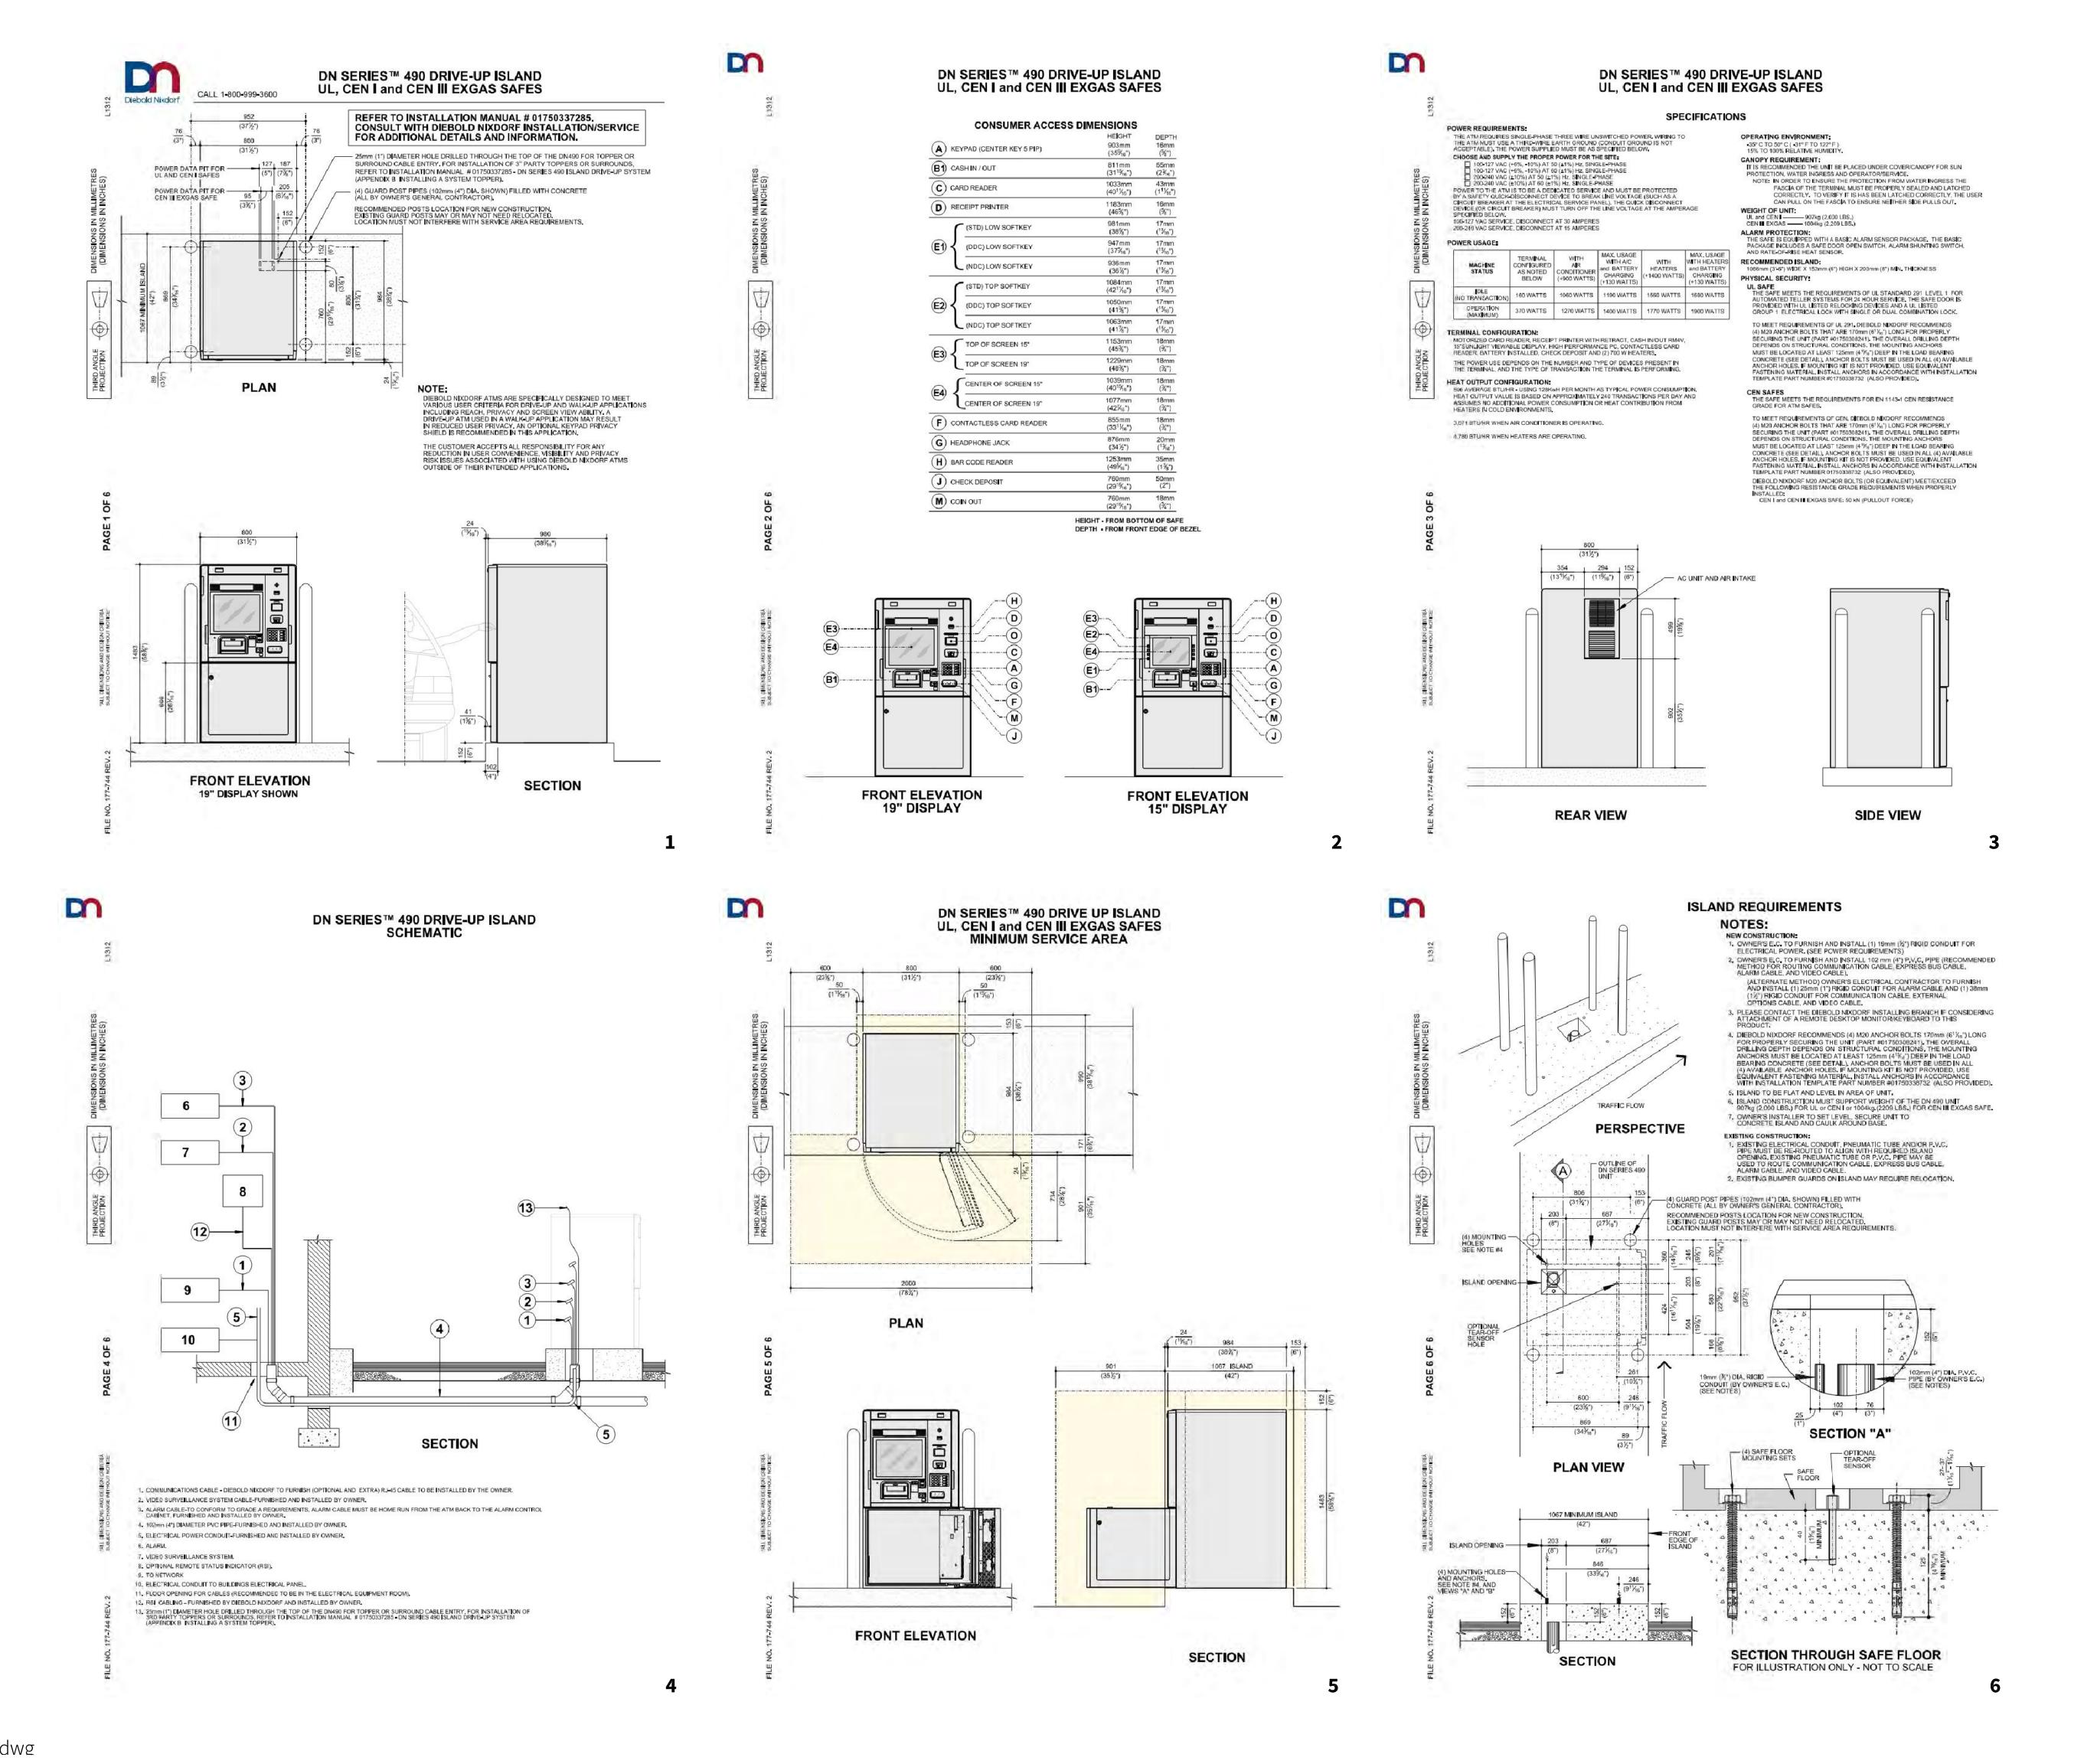
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COLORED ELEVATIONS
BY COMPANION



COLORED ELEVATIONS BY COMPANION SCALE: N.T.S.



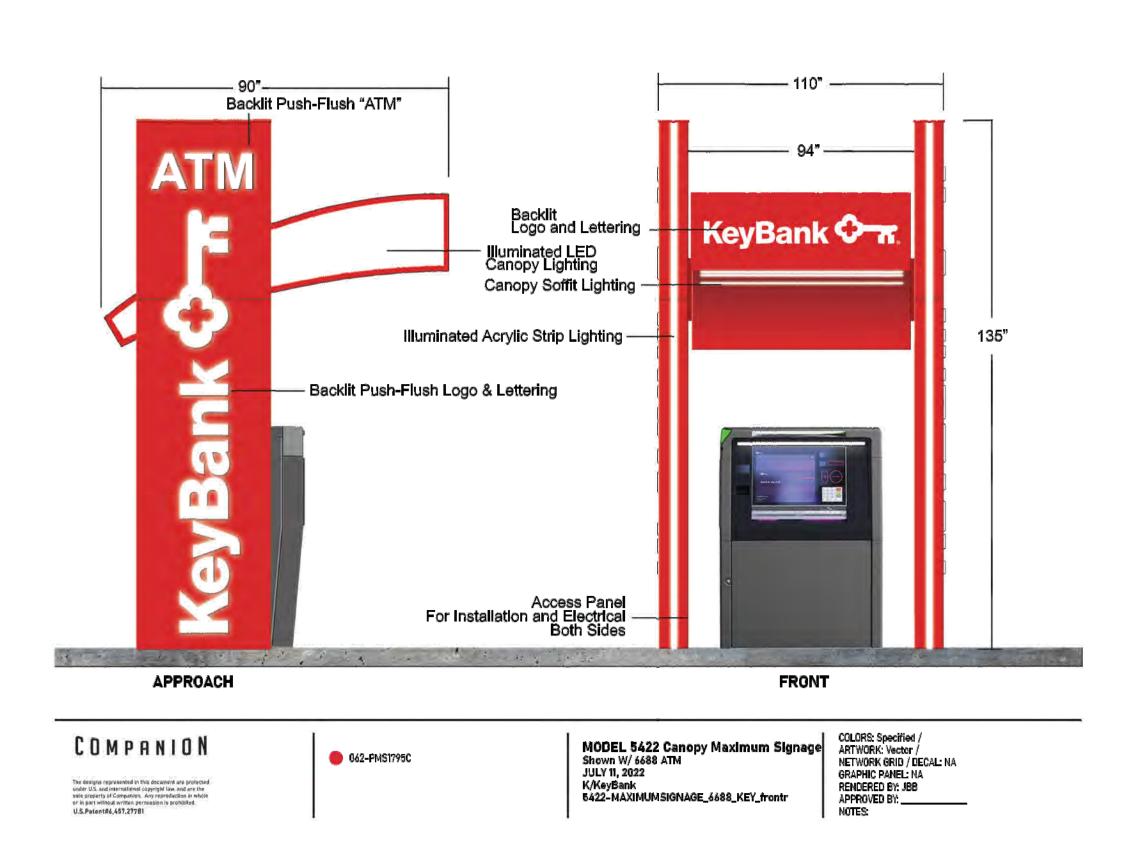

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1315938


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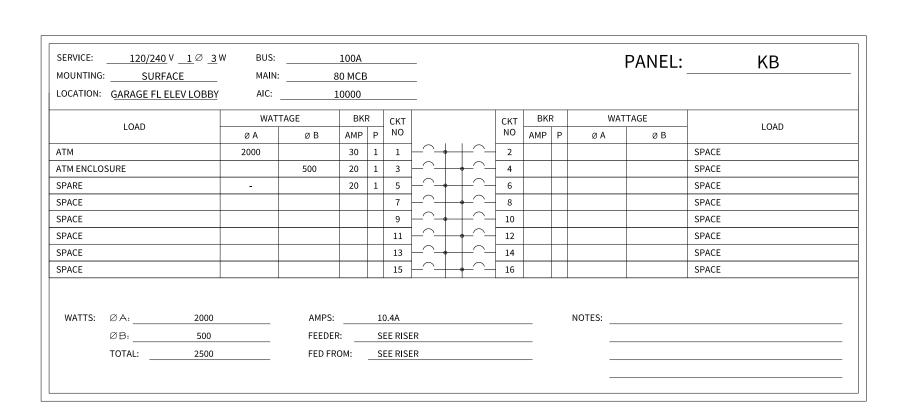
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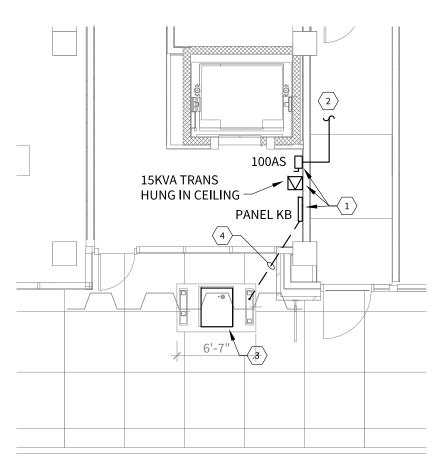
DIEBOLD NIXDORF SERIES 490 ATM SPECS





208V-3PH-4W 60A-3P MCB


25AF

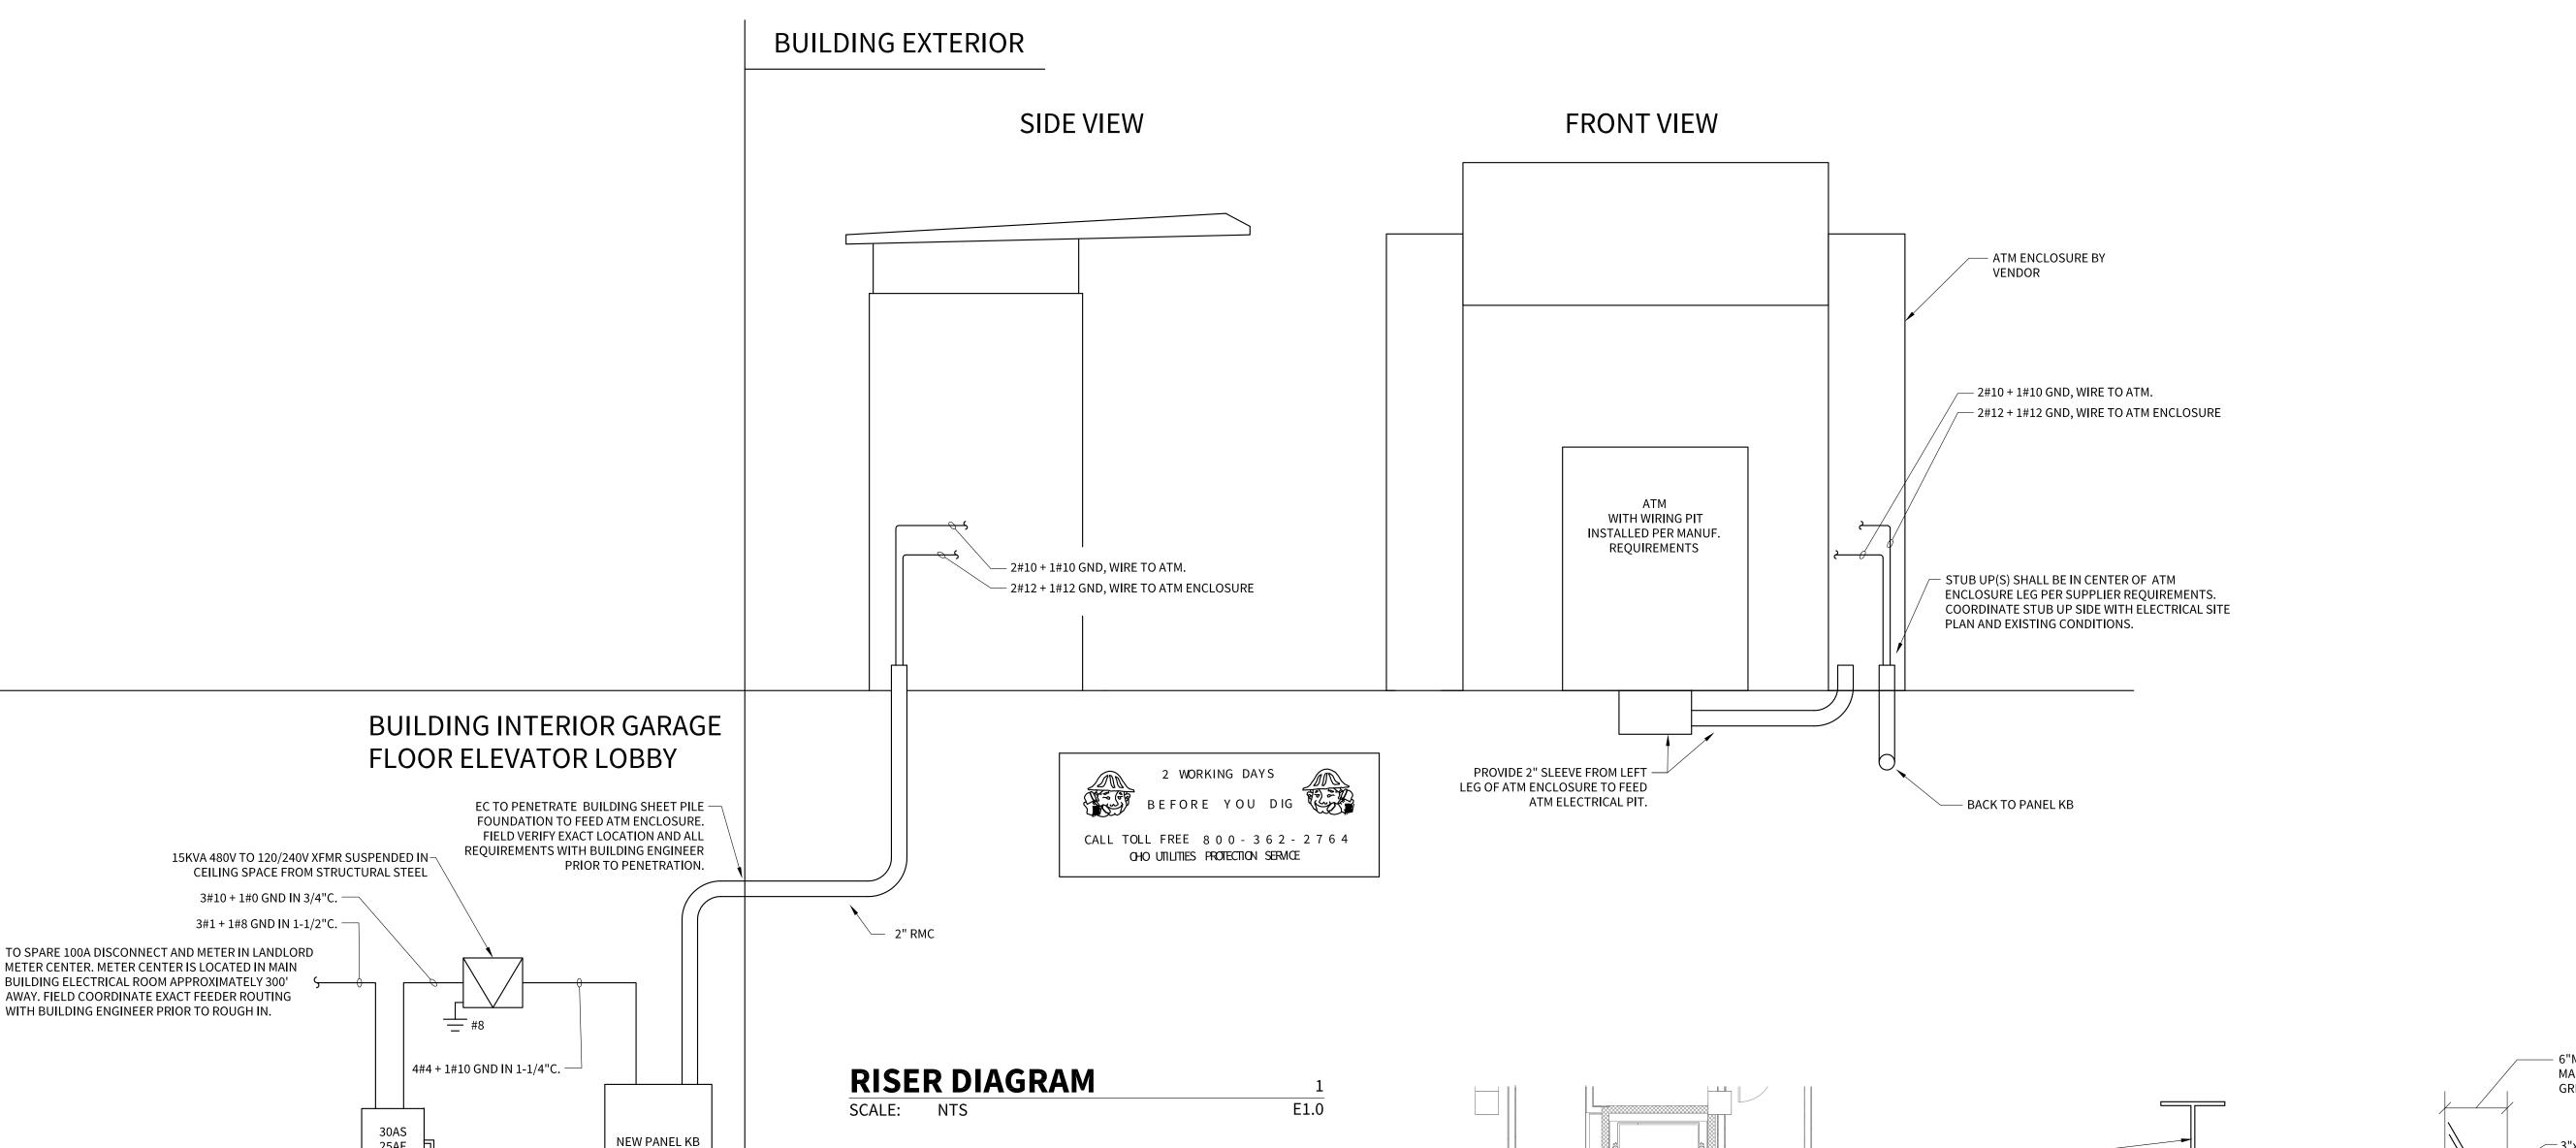

ELEC	CTRICAL PLAN	2
SCALE:	1/8" = 1'-0"	E1.0

CODED NOTES:

- NEW EQUIPMENT INDICATED SHALL BE MOUNTED IN GARAGE LEVEL ELEVATOR LOBBY DIRECTLY BELOW MAIN LEVEL LOBBY/ENTRANCE.
 - 3#1 + 1#8 GND IN 1-1/2"C FED FROM 100A DISCONNECT IN LANDLORD METER
- CENTER APPROXIMATELY 300' AWAY IN MAIN ELECTRICAL ROOM. ROUTE ROUTING WITH BUILDING ENGINEER PRIOR TO ROUGH IN.
- NEW ATM LOCATION. REFER TO COMPANION ANCHOR DETAILS FOR EXACT CONDUIT STUB UP DIMENSIONS AND REQUIREMENTS.
- 2"C FROM PANEL TO ATM CANOPY LEG. ROUTE CONDUIT UP TO GARAGE LEVEL CEILING SPACE, THROUGH BUILDING FOUNDATION, AND UP TO ATM CANOPY LEG. REFER TO COMPANION ANCHOR DETAILS FOR EXACT CONDUIT STUB UP DIMENSIONS AND REQUIREMENTS.

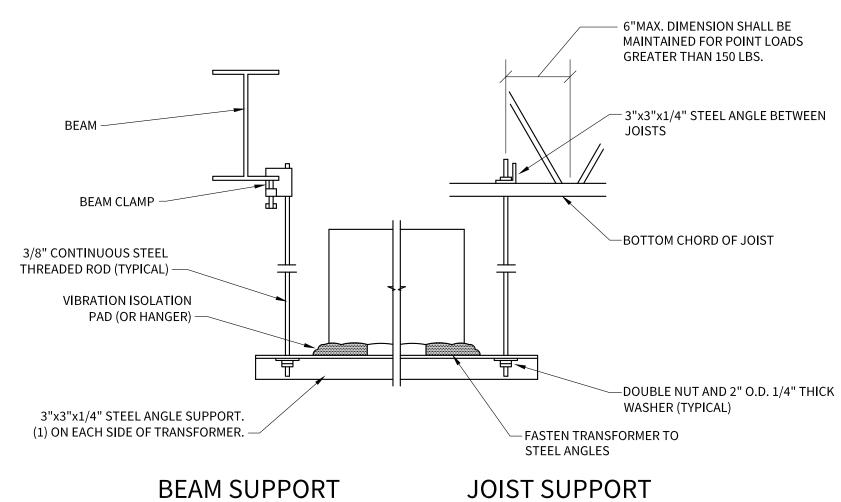

TRANSFORMER SUPPORT DETAIL SCALE: NTS E1.0



ARCHITECTS + ENGINEERS

1250 OLD RIVER ROAD, SUITE #201 CLEVELAND, OHIO 44113



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ELECTRICAL PLAN, RISER, AND DETAILS

NIGHT LIGHT

REMOVE EXISTING

RELOCATE EXISITNG

EXISTING TO REMAIN

EXISTING TO REMAIN, ETR

MECHANICAL CONTRACTOR

PLUMBING CONTRACTOR

ELECTRICAL CONTRACTOR

GROUNDING ELECTRODE CONDUCTOR

DUPLEX RECEPTACLE, 125VAC, 20A, MTD @ 18"AFF UNLESS OTHERWISE INDICATED. "C" DENOTES: MOUNT 8" ABOVE COUNTER.

DOUBLE DUPLEX RECEPTACLE, 125VAC, 20A, MTD @ 18"AFF UNLESS OTHERWISE INDICATED

DUPLEX RECEPTACLE, 125VAC, 20A, GROUND FAULT INTERRUPT, MTD @ 18"AFF UNLESS OTHERWISE INDICATED

DUPLEX RECEPTACLE, 125VAC, 20A, MTD @ 18"AFF UNLESS OTHERWISE INDICATED. TAMPER PROOF. (2)USB 5V DC CHARGING JACKS. HUBBELL #USB20X2

JUNCTION BOX

FIRE ALARM PULL STATION, MTD @ 48"AFF

FIRE ALARM HORN/SPEAKER AND STROBE, MTD @ 80"AFF

FIRE ALARM STROBE, MTD @ 80"AFF

FIRE ALARM HORN/SPEAKER

CEILING MOUNTED FIRE ALARM HORN/SPEAKER AND STROBE

CEILING MOUNTED FIRE ALARM STROBE

CEILING MOUNTED FIRE ALARM SPEAKER

FIRE ALARM CEILING SMOKE DETECTOR, 'E' INDICATES ELEVATOR RECALL

FIRE ALARM CEILING HEAT DETECTOR, 'E' INDICATES ELEVATOR SHUTDOWN

----SID DUCT DETECTOR. PROVIDE INTERLOCK CIRCUITING FOR FAN SHUT DOWN.

DUCT SMOKE DETECTOR REMOTE TEST STATION

DUCT SMOKE DETECTOR REMOTE TEST STATION WITH INTEGRAL AUDIBLE AND VISUAL ALARMS AND ANNUNCIATION

FACP FIRE ALARM CONTROL PANEL

FAAP FIRE ALARM ANNUNCIATOR PANEL

TELEVISION OUTLET, PROVIDE CHIEF BOX MODEL PAC525 WHERE APPLICABLE AND 1" EMPTY CONDUIT STUBBED UP TO ACCESSIBLE CEILING SPACE, PROVIDE PULL STRING

DOOR ACCESS SYSTEM CARD READER, PROVIDE BOX AND 3/4" EMPTY CONDUIT STUBBED UP TO ACCESSIBLE CEILING SPACE, PROVIDE PULL

DOOR ACCESS SYSTEM PUSH BUTTON, PROVIDE BOX AND 3/4" EMPTY CONDUIT STUBBED UP TO ACCESSIBLE CEILING SPACE, PROVIDE PULL

DOOR ACCESS SYSTEM KEYPAD, PROVIDE BOX AND 3/4" EMPTY CONDUIT STUBBED UP TO ACCESSIBLE CEILING SPACE, PROVIDE PULL

DOOR ACCESS SYSTEM 'DOOR RELEASE' PUSHBUTTON, PROVIDE BOX AND 3/4" EMPTY PRH RACEWAY STUBBED UP TO ACCESSIBLE CEILING SPACE, PROVIDE PULL STRING

DOOR ACCESS SYSTEM CHIME/BUZZER

TELE/DATA OUTLET, PROVIDE BOX AND 3/4" EMPTY CONDUIT STUBBED UP TO ACCESSIBLE CEILING SPACE, PROVIDE PULL STRING, MTD ⊚ 18"AFF UNLESS OTHERWISE INDICATED

WORKSTATION SYSTEMS FURNITURE TELE/DATA CABLE FEED LOCATION, PROVIDE BOX AND 1" EMPTY CONDUIT STUBBED UP TO ACCESSIBLE CEILING SPACE, PROVIDE PULL STRING, MTD @ 8"AFF UNLESS OTHERWISE INDICATED

WORKSTATION SYSTEMS FURNITURE POWER FEED LOCATION. PROVIDE FINAL CONNECTION TO SYSTEMS FURNITURE AS REQUIRED. MTD @ 8"AFF UNLESS OTHERWISE INDICATED.

2-CHANNEL POWER POLE FOR POWER AND TELE/DATA FEEDS TO WORKSTATION SYSTEMS FURNITURE. PROVIDE ALL REQUIRED COMPONENTS FOR A COMPLETE INSTALLATION. COORDINATE WITH FURNITURE SUPPLIER FOR

DUPLEX RECEPTACLE IN FULLY ADJUSTABLE FLUSH FLOOR BOX

DOUBLE DUPLEX RECEPTACLE IN FULLY ADJUSTABLE FLUSH FLOOR BOX

REQUIREMENTS.

TELE/DATA OUTLET IN FULLY ADJUSTABLE FLUSH FLOOR BOX

FIRE RATED POKE-THRU, DUPLEX AND TELE/DATA. (2)3/4" EMT - TELE/DATA 3/4" EMT - POWER

WALKER RC7ATCBK AND COM75. PROVIDE CONDUIT(S) SHOWN FROM POKE-THRU OVER TO AND UP THRU NEAREST AVAILABLE WALL/COLUMN/CHASE AND INTO ACCESSIBLE CEILING SPACE.

ELECTRICAL SPECIFICATIONS

- 1. THE GENERAL CONDITIONS OF THE CONTRACT. THE SUPPLEMENTARY CONDITIONS, ELECTRICAL DRAWINGS, MECHANICAL DRAWINGS. ARCHITECTURAL DRAWINGS, STRUCTURAL DRAWINGS, THE FOLLOWING SPECIFICATIONS, SHOP DRAWINGS, AND ANY ADDENDUMS TO THE ABOVE ARE PART OF THE CONTRACT FOR THE WORK. WORK SHALL BE GUARANTEED FOR ONE YEAR FROM DATE OF ACCEPTANCE BY THE OWNER AND ARCHITECT. AS-BUILT DRAWINGS SHALL BE PROVIDED.
- 2. THE ELECTRICAL CONTRACTOR SHALL VISIT THE SITE TO FAMILIARIZE HIMSELF WITH EXISTING CONDITIONS. NO ADDITIONAL COMPENSATION WILL BE AWARDED FOR UNNOTICED FIELD CONDITIONS.

ELECTRICAL WORK SHALL BE INSTALLED IN ACCORDANCE WITH THE NATIONAL ELECTRICAL CODE, ALL APPLICABLE FEDERAL, STATE, AND LOCAL CODES. THE ELECTRICAL CONTRACTOR SHALL SECURE AND PAY FOR ALL PERMITS AND INSPECTIONS REQUIRED TO

THE DRAWINGS INDICATE DIAGRAMMATICALLY THE LOCATIONS OF ELECTRICAL DEVICES, EQUIPMENT, FIXTURES AND THE METHOD OF CONNECTION. MATERIALS NOT SPECIFICALLY INDICATED BUT ESSENTIAL TO COMPLETE THE WORK SHALL BE INCLUDED.

"PROVIDE" SHALL MEAN FURNISH EQUIPMENT, ASSOCIATED APPURTENANCES, AND INSTALL SAME

THE SCOPE OF WORK SHALL INCLUDE, BUT IS NOT LIMITED TO:

A. CONDUIT, BRANCH CIRCUITS, OUTLETS AND WIRING.

B. LIGHTING FIXTURES, LAMPS, MOUNTING HARDWARE, SWITCHES, CONDUIT AND WIRING. C. EMERGENCY LIGHTING INCLUDING TESTING.

D. EXTENSION OF AND/OR RECONFIGURATION OF EXISTING POWER DISTRIBUTION SYSTEM.

E. DATA/TELEPHONE OUTLETS, CONDUITS AND PULL WIRES. F. ALL CHANNELING AND CONCRETE PATCHING WORK REQUIRED FOR ELECTRICAL WORK EXCLUSIVELY.

G. RECONNECTION, AS REQUIRED INCLUDING CONDUIT AND WIRE, OF ALL BRANCH CIRCUITS CUT OFF BY DEMOLITION OF EXISTING PARTITIONS, ETC.

H. NECESSARY CABINETS, JUNCTION BOXES, AND PULL BOXES.

I. TEMPORARY CONSTRUCTION POWER AND LIGHTING TO ACCOMMODATE ALL TRADES. J. GROUNDING OF ALL SYSTEMS AND EQUIPMENT.

K. EXTENSION OF AND/OR RECONFIGURATION OF EXISTING FIRE ALARM SYSTEM.

L. ELECTRICAL CONNECTION TO EQUIPMENT PROVIDED BY MECHANICAL AND/OR PLUMBING CONTRACTOR. FIELD VERIFY VOLTAGE, CURRENT, AND CONNECTION REQUIREMENTS FOR ALL EQUIPMENT PRIOR TO ROUGH-IN . NOTIFY ENGINEER IMMEDIATELY IF THERE ARE DISCREPANCIES BETWEEN WHAT IS SHOWN ON THESE DRAWINGS AND WHAT IS ACTUALLY REQUIRED. ALSO PROVIDE, LINE VOLTAGE CIRCUITING FOR AND FINAL CONNECTION TO CONTROLS TRANSFORMER(S). CONTROLS TRANSFORMER(S) AND LOW VOLTAGE CONTROLS CABLING BY MECHANICAL AND/OR PLUMBING CONTRACTOR.

- 4. ALL EQUIPMENT AND MATERIALS SHALL BE NEW AND BEAR UL LABELS AND LISTINGS. SUBMIT SHOP DRAWINGS FOR ALL EQUIPMENT PRIOR TO ORDERING FOR PROJECT.
- 5. COORDINATE WORK WITH OTHER TRADES FOR SPACE REQUIREMENTS. THE ELECTRICAL CONTRACTOR SHALL BE RESPONSIBLE FOR CUTTING AND PATCHING REQUIRED FOR THE INSTALLATION OF THE ELECTRICAL WORK. VERIFY DEVICE LOCATIONS WITH ARCHITECT PRIOR TO ROUGH-IN.

A. SUPPORT CONDUIT FROM BUILDING STRUCTURE ONLY. INSTALL 1/16" PULL STRING IN ALL EMPTY CONDUITS. NO PVC SHALL BE PERMITTED ABOVE GRADE WITHIN THE BUILDING.

B. USE TYPE MC CABLE FOR FISHING NEW CIRCUITS THROUGH EXISTING WALLS AND FOR LIGHTING FIXTURE WHIPS. FLEXIBLE METAL CONDUIT SHALL BE USED FOR THE FINAL CONNECTION TO TRANSFORMERS AND MOTORS. FLEXIBLE LIQUID-TIGHT CONDUIT

SHALL BE USED FOR FINAL CONNECTION TO ALL HARD-WIRED EQUIPMENT. C. ABOVE GRADE INTERIOR DRY LOCATION CONDUIT SHALL BE ELECTRICAL METALLIC TUBING(EMT) WITH SET SCREW FITTINGS CONCEALED IN WALLS OR ABOVE CEILINGS.

D. ABOVE GRADE EXTERIOR CONDUIT SHALL BE RIGID METAL CONDUIT(RMC) WITH THREADED FITTINGS. E. BELOW GRADE CONDUIT SHALL BE SCHEDULE 40 RIGID NONMETALLIC CONDUIT(RNC) WITH FITTINGS APPROVED FOR USE WITH

RNC. TRANSITION TO EMT OR RMC ABOVE GRADE. F. IF APPROVED BY LANDLORD, MC CABLE MAY BE USED FOR RECEPTACLE, LIGHTING, AND EQUIPMENT BRANCH CIRCUITING. INSTALL CONCEALED IN WALLS OR ABOVE CEILINGS.

7. FIRE STOP ALL WALL AND FLOOR PENETRATIONS PER UL APPROVED METHOD AT RATED ASSEMBLIES.

8. WIRE AND CABLE

- A. WIRE AND CABLE SHALL BE 600V TYPE THWN COPPER UNLESS OTHERWISE INDICATED. WIRE #8 AND LARGER SHALL BE STRANDED CONDUCTOR. WIRE #10 AWG AND SMALLER SHALL BE SOLID CONDUCTOR.
- B. UNLESS OTHERWISE INDICATED, NO WIRE SMALLER THAN #12 AWG SHALL BE USED. CONTROL CIRCUITS MAY BE #14 AWG. C. UNLESS OTHERWISE INDICATED, PRESUME WIRE SIZE TO BE #12 AWG.
- D. ALL 120V, 20A HOMERUNS GREATER THAN 75 FEET SHALL BE #10 AWG. ALL 277V, 20A HOMERUNS GREATER THAN 150 FEET SHALL
- BE #10 AWG. E. SEPARATE INSULATED GROUNDING WIRES SHALL BE INSTALLED IN ALL CONDUIT RUNS FOR POWER AND LIGHTING. MINIMUM SIZE
- OF GROUND SHALL BE PER THE NEC ARTICLE 250. F. ALL EQUIPMENT AND RECEPTACLE CIRCUITS SHALL BE PROVIDED WITH DEDICATED NEUTRAL CONDUCTORS (NO SHARED NEUTRALS).

208Y/120 VOLTS 480Y/277 VOLTS G. COLOR CODE WIRING AS FOLLOWS:

ORANGE **YELLOW** WHITE WHITE/BLACK STRIPE GREEN

- 9. PANEL DIRECTORIES SHALL BE TYPED. PROVIDE AND INSTALL ENGRAVED PHENOLIC NAMEPLATES FOR MOTOR STARTERS, PANELBOARDS, SAFETY SWITCHES ETC.
- 10. TEST WIRING SYSTEMS FOR SHORTS AND GROUNDS PRIOR TO ENERGIZING CIRCUITS.

WIRING DEVICES SHALL BE AS FOLLOWS:	DEVICE	HUBBELL NU
	SINGLE POLE SWITCH	HBL1221
	THREE-WAY SWITCH	HBL1223
	FOUR-WAY SWITCH	HBL1224
	DUPLEX RECEPTACLE	HBL5362
	DUPLEX RECEPTACLE GFI	GF5362

WIRING DEVICE AND COVER PLATE COLOR SHALL BE AS SELECTED BY ARCHITECT. COVER PLATES SHALL BE HIGH-IMPACT NYLON. WIRING DEVICES SHALL BE HUBBELL, PASS & SEYMOUR, OR EQUAL

ELECTRICAL DEMOLITION NOTES

- 1. HOLES IN ROOM SURFACES DUE TO THE REMOVAL OF ELECTRICAL WORK SHALL BE PATCHED TO MATCH EXISTING FINISH. OPENINGS IN FIRE RATED PARTITIONS SHALL BE SEALED WITH FIRE RATED MATERIAL
- 2. COORDINATE DEMOLITION SUCH THAT EXISTING EMBEDDED CONDUIT AND FLUSH BOXES IN MASONRY WALLS AND CEILINGS MAY BE REUSED TO THE EXTENT POSSIBLE. FLUSH OUTLET BOXES THAT ARE NOT REUSED SHALL BE PROVIDED WITH BLANK PLATES.
- 3. DEVICES SHOWN WITH 'REX' SHALL BE REMOVED COMPLETELY INCLUDING ALL ASSOCIATED WIRING AND CONDUIT. CIRCUITING AFFECTED SHALL BE REROUTED TO OTHER ACTIVE DEVICES SHARING THAT CIRCUIT AS REQUIRED.
- 4. DEVICES SHOWN WITH 'ETR' SHALL REMAIN. PROTECT DURING DEMOLITION. DEVICES IN CEILINGS THAT ARE TO BE REPLACED SHALL BE REMOVED TEMPORARILY AND REINSTALLED.
- 5. DEVICES SHOWN WITH 'REL' SHALL BE RELOCATED. EXTEND CIRCUIT(S) AS REQUIRED.
- 6. ELECTRICAL DEMOLITION INCLUDES BUT IS NOT LIMITED TO THE RELOCATION OF AND/OR REMOVAL OF ALL ELECTRICAL RELATED DEVICES (UNLESS OTHERWISE INDICATED) LOCATED ON, IN, AND/OR THROUGH WALLS AND CEILINGS SHOWN TO BE DEMOLISHED ON THE ARCHITECTURAL PLANS. CIRCUITING AFFECTED SHALL BE REROUTED TO OTHER ACTIVE DEVICES SHARING THAT CIRCUIT
- 7. RECONFIGURATION OF ACTIVE TELECOMMUNICATIONS WIRING/CABLING BY OTHERS.
- 8. REMOVE ACCESSIBLE PORTION OF ABANDONED TELECOMMUNICATIONS WIRING/CABLING.
- 9. REX ALL UNUSED WORK BOXES, JUNCTION BOXES, CONDUIT, ETC.
- 10. UNLESS INDICATED OTHERWISE, REX ALL UNUSED BRANCH CIRCUITS BACK TO BRANCH CIRCUIT PANEL AND TAG CIRCUIT BREAKER AS 'SPARE'.
- 11. NO ATTEMPT HAS BEEN MADE TO INDICATE ALL EXISTING ELECTRICAL DEVICES TO BE REMOVED AND/OR RELOCATED. HOWEVER, THE ELECTRICAL CONTRACTOR SHALL FIELD VERIFY THE EXTENT OF DEMOLITION PRIOR TO SUBMITTING BID. REMOVE AND/OR RELOCATE EXISTING ELECTRICAL DEVICES ON WALLS OR CEILING BEING REMOVED. COORDINATE SUCH CONDITIONS WITH
- 12. ELECTRICAL CONTRACTOR TO MAKE SAFE ALL ELECTRICAL PANELBOARDS, DEVICES, EQUIPMENT, ETC. DURING DEMOLITION PHASE, TAKE ALL NECESSARY PRECAUTIONS SUCH AS PROVIDING LOCK-OUT DEVICES, REMOVAL OF CIRCUITING, DISCONNECT POWER TO ANY AND ALL EQUIPMENT SLATED TO BE REMOVED, ETC.

- 12. TELEPHONE AND DATA EQUIPMENT AND WIRE SHALL BE FURNISHED AND INSTALLED BY OTHERS UNDER SEPERATE CONTRACT WITH OWNER. COORDINATE WITH OWNER.
- 13. CEILING CAVITY IS A RETURN AIR PLENUM. EXPOSED LOW VOLTAGE COMMUNICATIONS, TELEPHONE, SECURITY AND OTHER MISCELLANEOUS WIRING SHALL BE SUITABLE FOR INSTALLATION IN AIR HANDLING PLENUMS PER NEC.
- 14. THE ELECTRICAL CONTRACTOR IS CAUTIONED THAT THE BUILDING IS OCCUPIED AND WORK SHALL NOT INTERFERE WITH THE NORMAL OPERATION OF THE BUILDING AND ITS TENANTS. THE PROJECT SHALL BE MANAGED AT ALL TIMES BY A COMPETENT FOREMAN.

15. POWER DISTRIBUTION

- A. PANELBOARDS SHALL BE ENCLOSED TYPE, CABINETS OF CODE GAUGE STEEL WITH CONCEALED STEEL TRIM HINGES AND FLUSH TYPE LOCKS. BACK BOXES SHALL BE CODE GAUGE STEEL. DOORS AND TRIM SHALL BE ONE-PIECE WITH 180 DEGREE MOVEMENT. PROVIDE SEPARATE EQUIPMENT GROUND, NEUTRAL, AND ISOLATED GROUND BUSSES AS INDICATED. PANELBOARDS SHALL BE EQUIPPED WITH BOLT-ON MOLDED-CASE CIRCUIT BREAKERS OF THE TYPE, POLES AND TRIP RATINGS, AS INDICATED WITH INTERRUPTING CAPACITY PER BUILDING REQUIREMENTS.
- B. TRANSFORMERS SHALL BE DRY TYPE, 150°C RISE MAXIMUM, TWO(2) TAPS ABOVE AND TWO(2) TAPS BELOW NORMAL RATED VOLTAGE, SOUND LEVELS SHALL NOT EXCEED NEMA STANDARDS. PROVIDE MOUNTING AS SHOWN ON THE PLANS.
- C. DISCONNECT SWITCHES SHALL BE HEAVY DUTY WITH DUAL-INTERLOCKED BOX COVERS, FUSED OR NON-FUSED, WITH NUMBER OF POLES AND SIZES AS SHOWN ON THE PLANS. PROVIDE NEUTRAL ASSEMBLY AND GROUND LUGS WHERE REQUIRED. ENCLOSURE SHALL BE NEMA TYPE 1 FOR DRY AND INDOOR LOCATIONS. ENCLOSURE SHALL BE NEMA TYPE 3R FOR WET, SPRINKLED, AND OUTDOOR LOCATIONS. FUSES SHALL BE DUAL ELEMENT BY BUSSMAN OR FERRAZ-SHAWMUT.
- D. PROVIDE PRODUCTS MANUFACTURED BY SQUARE-D OR APPROVED EQUAL BY CUTLER-HAMMER OR GENERAL ELECTRIC. E. ELECTRICAL EQUIPMENT LOCATION IS SHOWN ON PLANS TO INDICATE INTENT ONLY. FIELD COORDINATE ACTUAL INSTALLATION LOCATION. ACTUAL INSTALLATION LOCATION SHALL SATISFY WORKING SPACE AND DEDICATED ELECTRICAL SPACE REQUIREMENTS. FIELD COORDINATE ACTUAL INSTALLATION LOCATION TO AVOID CONFLICTS WITH OTHER EQUIPMENT, SYSTEMS,
- F. CONTRACTOR SHALL CALCULATE OR ENGAGE AN ENGINEER TO CALCULATE MAXIMUM AVAILABLE FAULT CURRENT AT SERVICE EQUIPMENT. CONTRACTOR SHALL FIELD MARK SERVICE EQUIPMENT WITH THE DATE THE THE CALCULATION WAS PERFORMED AND THE MAXIMUM AVAILABLE FAULT CURRENT. ALL PER NEC 110.24.
- G. WHEN MODIFICATIONS TO THE ELECTRICAL INSTALLATION OCCUR THAT AFFECT THE MAXIMUM AVAILABLE FAULT CURRENT CONTRACTOR SHALL VERIFY OR RECALCULATE OR ENGAGE AN ENGINEER TO CALCULATE MAXIMUM AVAILABLE FAULT CURRENT AT SERVICE EQUIPMENT. CONTRACTOR SHALL FIELD MARK SERVICE EQUIPMENT WITH THE DATE THE THE CALCULATION WAS PERFORMED AND THE MAXIMUM AVAILABLE FAULT CURRENT. ALL PER NEC 110.24.

16. NEW UTILITY SERVICE

- A. PROVIDE NEW UTILITY SERVICE AND ASSOCIATED EQUIPMENT.
- B. CONTRACTOR IS RESPONSIBLE FOR CONTACTING ELECTRIC UTILITY, COORDINATING SERVICE REQUIREMENTS, ARRANGING UTILITY CONNECTION, AND PAYING FOR ALL ASSOCIATED UTILITY CHARGES/FEES.
- C. COORDINATE ALL OUTAGES WITH OWNER AND THE UTILITY. ALL SCHEDULED OUTAGES SHALL BE DURING TIMES WHEN THE BUILDING IS NOT IN USE.

17. LIGHTING

PLAN NOTES

- A. PROVIDE LIGHTING FIXTURES AS SHOWN IN THE LIGHTING FIXTURE SCHEDULE OR APPROVED EQUAL B. BALLASTS SHALL BE HIGH POWER FACTOR ELECTRONIC WITH TYPE-A SOUND RATING AND FUSED WITH BUSSMAN GLR FUSE IN HLR HOLDER. VOLTAGE AS SPECIFIED IN LIGHTING FIXTURE SCHEDULE. PROVIDE LUTRON HI-LUME, OR APPROVED EQUAL, DIMMING BALLASTS FOR FLUORESCENT FIXTURES SHOWN ON THE PLAN TO BE DIMMED.
- C. LAMPS SHALL BE OSRAM SYLVANIA, GENERAL ELECTRIC, OR APPROVED EQUAL D. INTENSITY OF EMERGENCY LIGHTING SHALL BE ONE FOOT-CANDLE. ELECTRICAL CONTRACTOR SHALL FURNISH AND INSTALL ADDITIONAL EMERGENCY LIGHT UNITS TO MEET THIS REQUIREMENT IF NECESSARY.
- E. VERIFY CEILING CONSTRUCTION WITH THE GENERAL CONTRACTOR AND COORDINATE LIGHT FIXTURE MOUNTING WITH CEILING CONSTRUCTION. SUPPORT ALL RECESSED LIGHTING FIXTURES INDEPENDENTLY OF CEILING SUSPENSION SYSTEMS. INSTALL LIGHT FIXTURES TO PRECLUDE CONTACT WITH INSULATION MATERIAL
- F. FINAL CONNECTION TO LIGHTING FIXTURES SHALL BE WITH FLEXIBLE METAL CONDUIT OR MC CABLE FIXTURE WHIPS NO MORE G. LIGHTING FIXTURES SHALL BE EQUIPPED WITH AN ACCESSIBLE DISCONNECTING MEANS LOCATED AT EACH INDIVIDUAL FIXTURE.

1. FIELD VERIFY MOUNTING HEIGHTS AND LOCATIONS OF ALL DEVICES PRIOR TO ROUGH-IN. NOTIFY THE ARCHITECT OR

2. CONTRACTOR SHALL FIELD VERIFY EXISTING CONDITIONS AND SHALL NOTIFY THE ARCHITECT OR ENGINEER IN WRITING OF

3. ALL EXIT SIGNS, NIGHT LIGHTS, EMERGENCY LIGHTING UNITS, AND EMERGENCY BATTERY PACKS SHALL BE CONNECTED TO

4. EXISTING SYSTEMS, DEVICES, FIXTURES, CIRCUITING, ETC. THAT ARE SHOWN ON THESE PLANS ARE BASED ON VISUAL

EXISTING CONDITIONS, THE EXTENT OF HIS WORK, AND INTERFERENCE BY OTHER TRADES WITH HIS WORK. ANY

DISCREPANCIES SHOULD BE DISCUSSED WITH THE ARCHITECT OR ENGINEER.

TO PREVENT THE CIRCULATION OF WARM AIR TO A COLDER SECTION OF THE RACEWAY.

ENGINEER IMMEDIATELY OF ANY DISCREPANCIES AND/OR CONFLICTS WHICH MAY INTERFERE WITH THE PROPER INSTALLATION

ANY DISCREPANCIES AND/OR DAMAGED EXISTING BASE BUILDING WORK WHICH MAY INTERFERE WITH THE PROPER EXECUTION

CIRCUIT AHEAD OF LOCAL SWITCHING. CONNECT TO THE LIGHTING CIRCUIT SERVING THE AREA SERVED BY THE EXIT AND/OR

INSPECTION AND/OR AS-BUILT DRAWINGS, BUT MAY NOT REFLECT THE ACTUAL CONDITIONS IN EVERY CASE. THE ELECTRICAL

CONTRACTOR SHALL INSPECT THE SITE AND EXAMINE THE WORK BEFORE SUBMITTING HIS PROPOSAL. HE SHALL NOTE THE

5. CIRCUITING SHOWN TO EXISTING PANELS IS SHOWN ON DRAWINGS FOR INDICATING INTENT ONLY. FIELD VERIFY EXISTING

OTHERWISE, EXISTING CIRCUITS BEING FED FROM EXISTING CB'S SHALL REMAIN. IF A CIRCUIT NUMBER SHOWN ON THE

DRAWING INDICATES CIRCUITING TO A CB REQUIRED TO SERVE AN EXISTING CIRCUIT, USE THE NEXT AVAILABLE CB OF THE

SIZE AND CONFIGURATION REQUIRED. IF EXISTING CB IS NOT AVAILABLE, PROVIDE NEW CB IN EXISTING PANEL SPACE AS

PROGRAMMING TO INTERFACE WITH AND/OR EXTEND THE EXISTING FIRE ALARM SYSTEM AND TO COORDINATE WITH EXISTING

CIRCUITING, EXISTING CIRCUIT NUMBERS AND/OR SPARES, AND SPACES AVAILABLE IN PANELS. UNLESS INDICATED

6. CONTRACTOR TO PROVIDE ALL NECESSARY COMPONENTS (AMPLIFIERS, REPEATERS, EXPANDER PANELS, ETC.) AND/OR

7. RACEWAY PASSING FROM THE INTERIOR TO THE EXTERIOR OF THE BUILDING SHALL BE FILLED WITH AN APPROVED MATERIAL

REQUIRED. FIELD VERIFY EXISTING PANELS HAVE ADEQUATE CAPACITY TO HANDLE ADDITIONAL LOADS.



ARCHITECTS + ENGINEERS

1250 OLD RIVER ROAD, SUITE #201 CLEVELAND, OHIO 44113




DATE 12/5/2022 PERMIT SET


DRAWN BY 22375 JOB NO.

SPECIFICATION





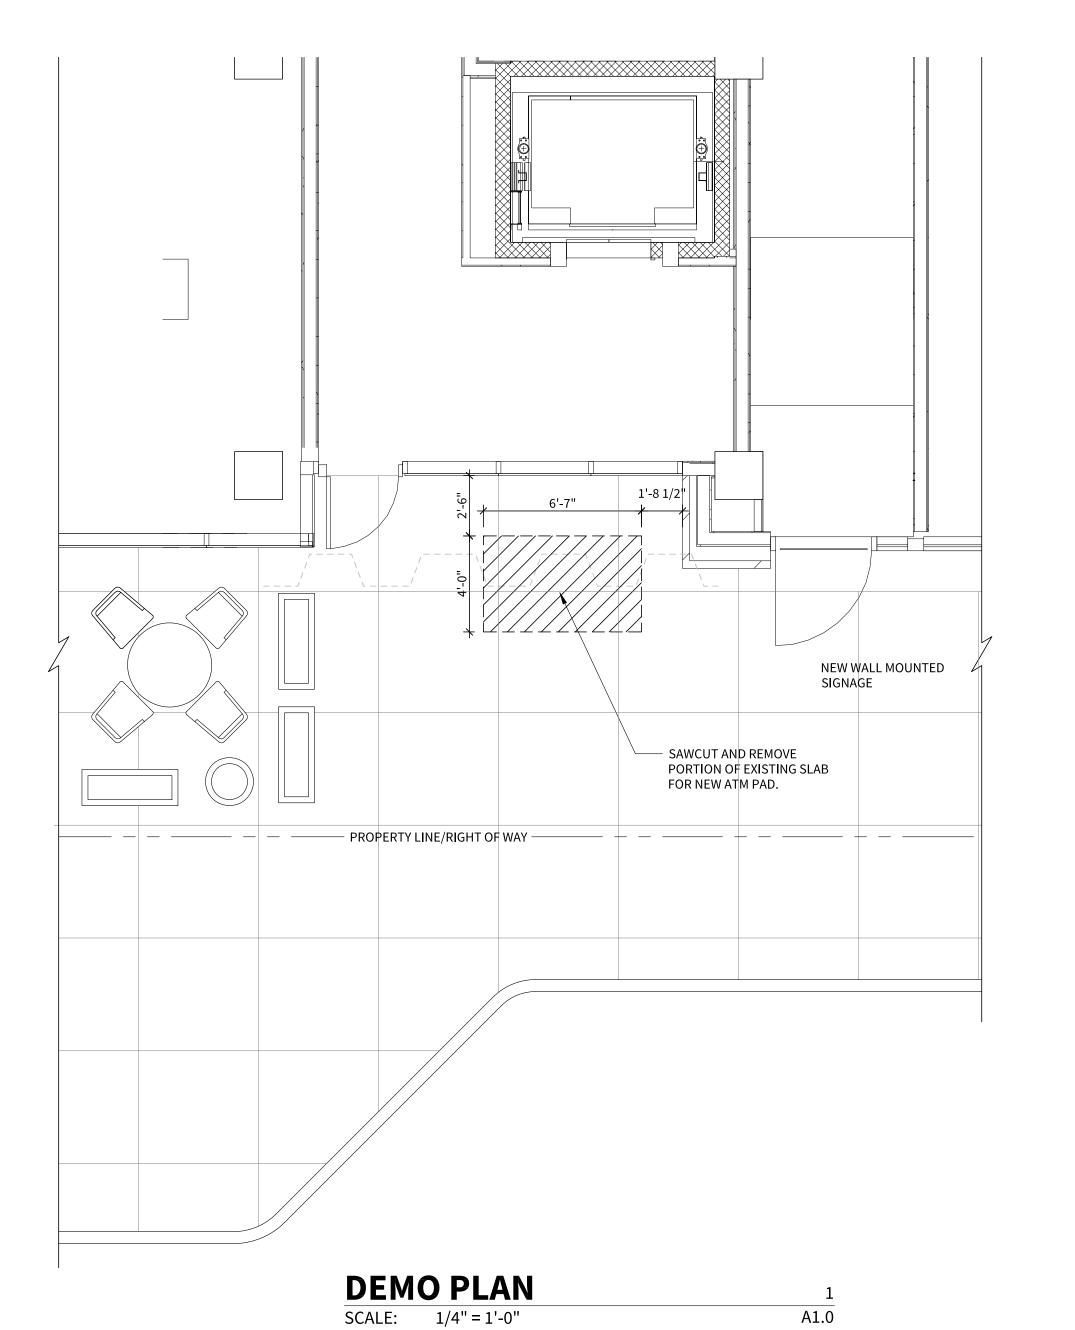

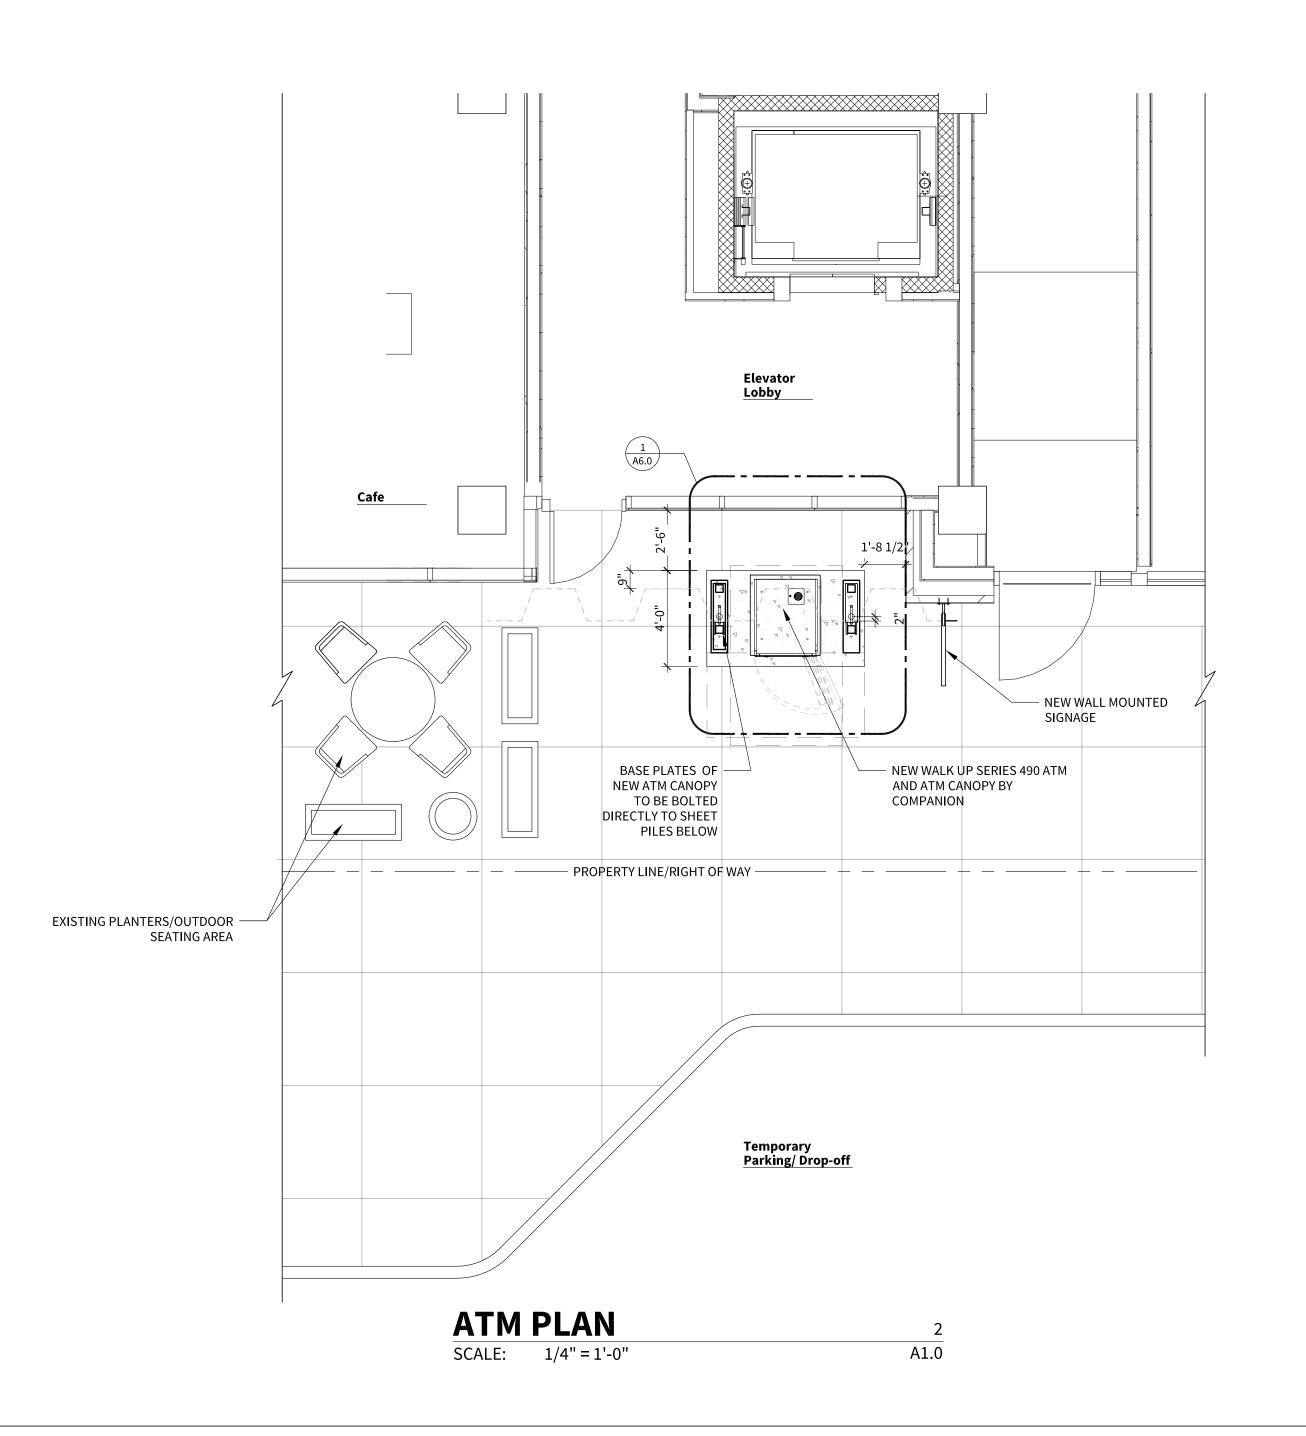



ARCHITECTS + ENGINEERS

1250 OLD RIVER ROAD, SUITE #201 CLEVELAND, OHIO 44113 W W W . H S B A R C H . C O M

* Ben Gingrich * 1315938

Expiration: Dec. 31, 2023

ISSUE	DATE
PERMIT SET	12/5/2022


DRAWN BY: JOB NO.

мР 22375

YBANK DRIVE-UP ATM WALK-UP ATM & CANOPY


ENLARGED SITE PLAN

AS1.0

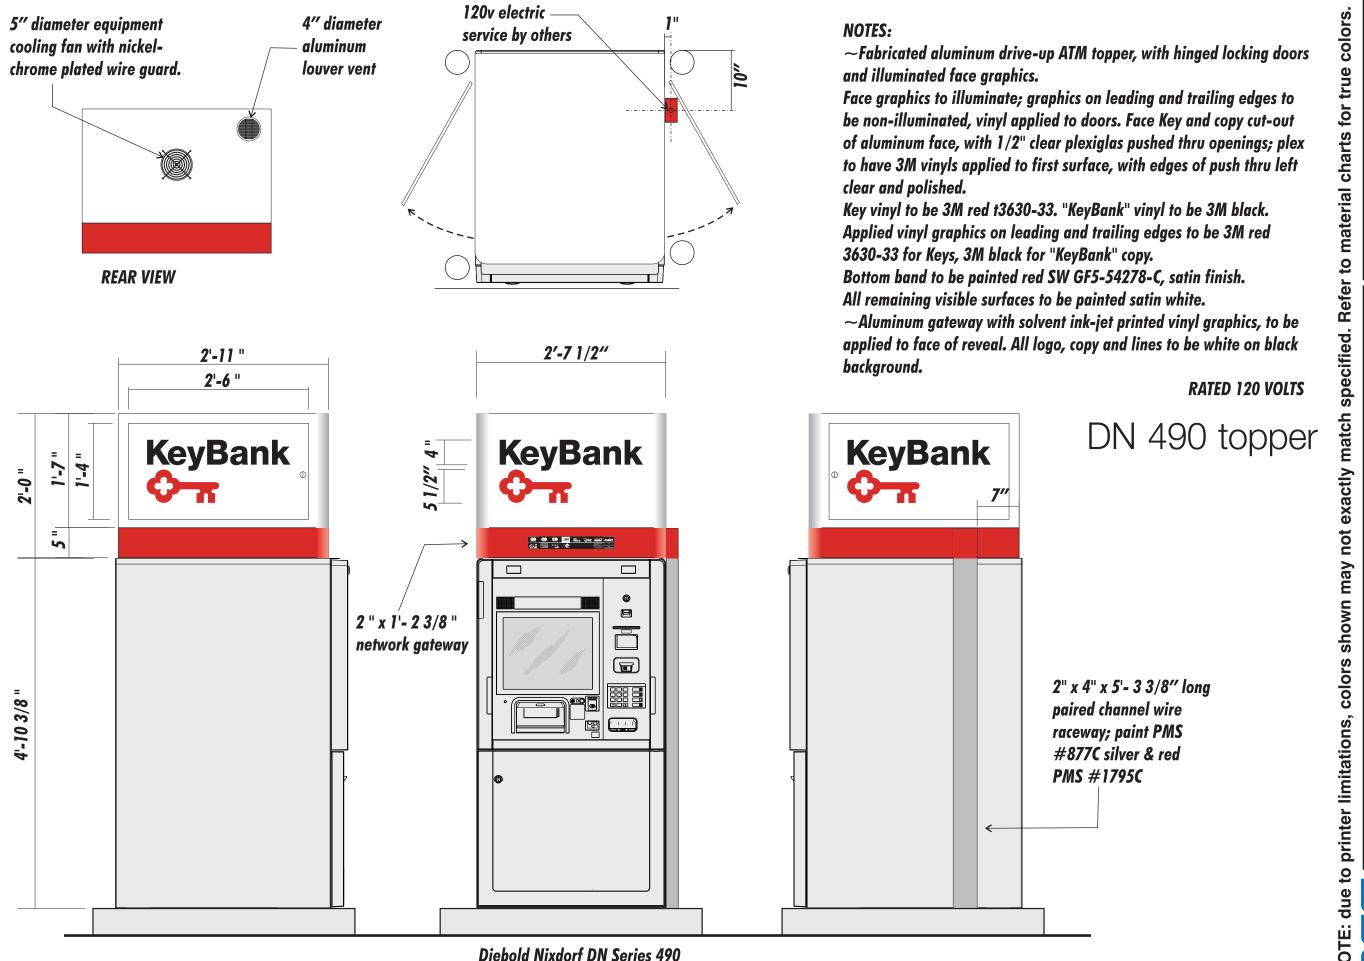

FILE NAME N/key OH/2011 west 25th ATM

(216)741-3800 **OHIO 44131** Sign Electric Cleveland, Ohio VAN EPPS RD., **Brilliant**

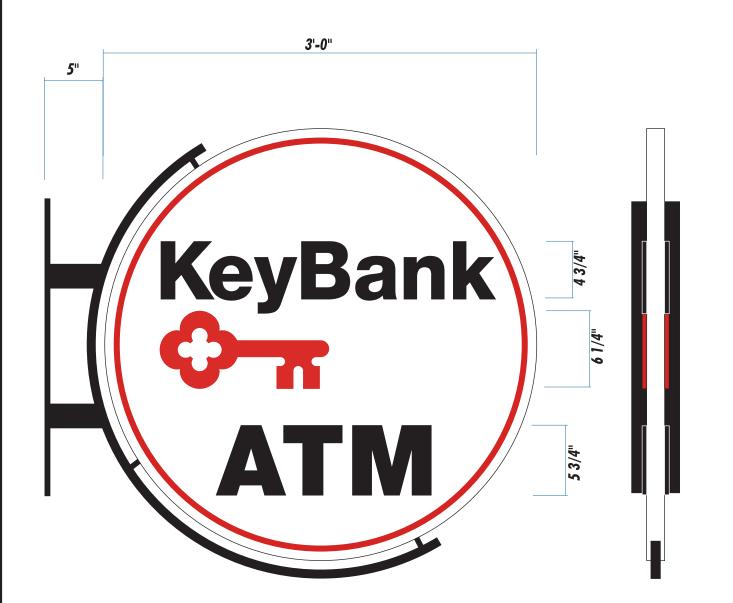



INSTALLATION ELEVATION SCALE 1/4"=1'-0"

NOTES:

Double-face, non-illuminated fabricated aluminum projecting sign with dimensional copy and steel mounting bracket.

Main sign panel to be fabricated aluminum painted white with red PMS 1795C inset border.

All copy to be 3/8" PVC, painted black and flush mounted to background.

Key logo to be 3/8" PVC, painted red to match PMS 1795C and flush mounted to background.

Steel bracket to be painted black.

to material charts for printer limitations, colors



DIIIIAII EIECITIC SIGII CO., LIG. IS SUBMITTED FOR COLUNCTION WITH		., LIQ.	DRAWING, CREATE IS SUBMITTED FOR CONJUNCTION WITH
4811 VAN EPPS RD., CLEVELAND, OHIO 44131 (216)741-3800	0 44131 (2	16)741-3800	COPIED OR EXH
ME KeyBank	SALESMAN H	DATE 9-30-22	REVISION
	DESIGNER	SCALE	

NAMEN/key OH/2011 west 25th ATM

Design Review



Staff Report



Certificate of Appropriateness

January 26, 2023



Case 23-005: Ohio City Historic District

Lutheran School of Phlebotomy – 2706 Franklin Boulevard

Ramp Installation

Ward 3: McCormack

Project Representatives: Erica Hillow, Anthony Rodriguez (Vocon), Matthew

MacRaild (Cleveland Clinic)

vocon.

FINAL DESIGN REVIEW PACKAGE:

OHIO CITY LOCAL HISTORIC DESIGN REVIEW & LANDMARKS COMMISSION

JANUARY 26, 2023

PHASE II: LUTHERAN SCHOOL OF PHLEBOTOMY 2706 FRANKLIN DRIVE CLEVELAND, OH 44113

EXISTING CONDITIONS




2706 FRANKLIN





EXISTING CONDITIONSSITE LOCATION AND ZONING

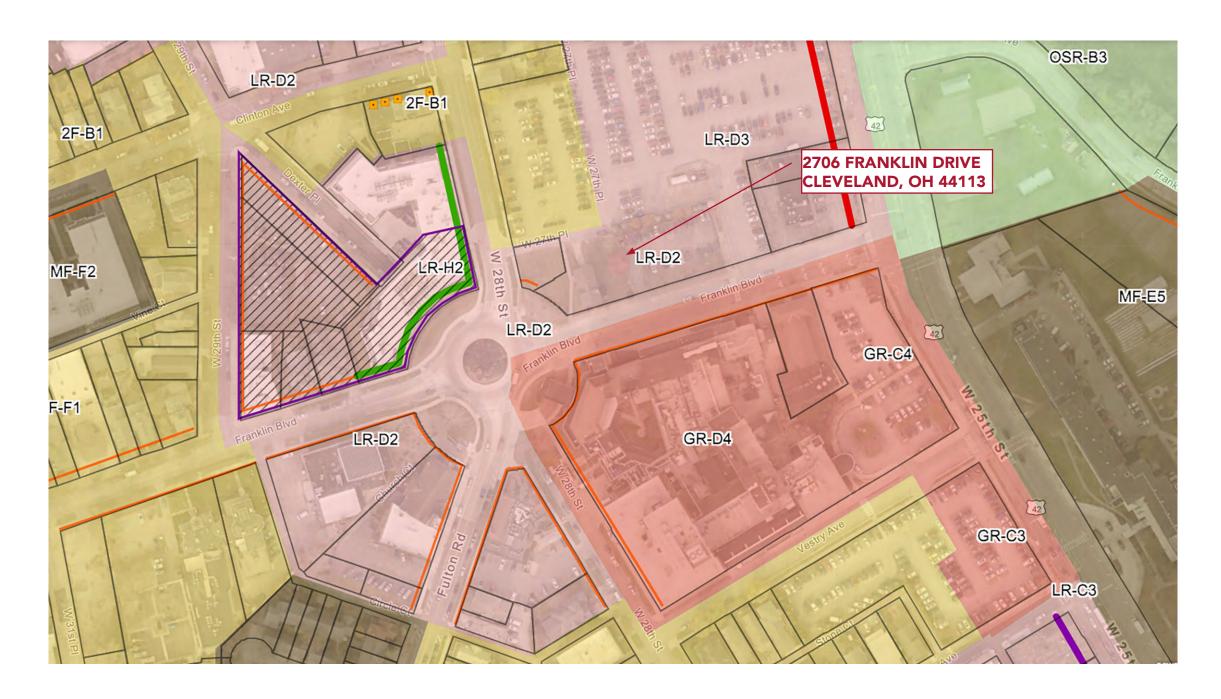

2706 FRANKLIN BLVD

CURRENT ZONING

Area District: D Height District: 2

Use District: Local Retail Business

Zone Code: LR-D2

DESIGN REVIEW REGIONS

Near West

NATIONAL HISTORIC DISTRICTS

Ohio City Preservation District


LOCAL LANDMARK DISTRICTS
Ohio City (Takes Precedents)

CLEVELAND PARCELS

Parcel #: 00328016


Address: 1532 W 25th St. Cleveland, OH 44113

Owner: Lutheran Hospital

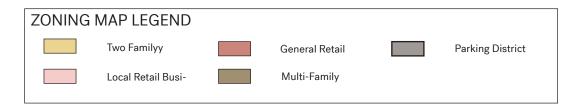



NORTH ELEVATION

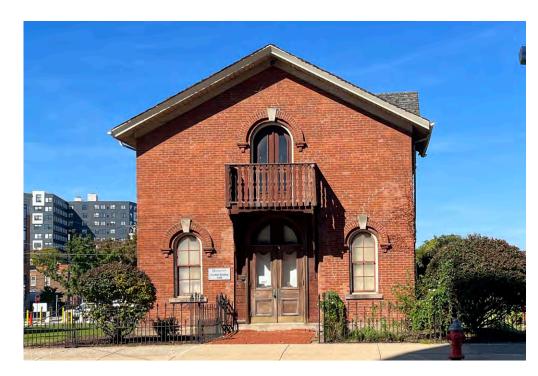

SOUTH ELEVATION



NORTHWEST ELEVATION



SOUTHWEST ELEVATION



EXISTING CONDITIONS

WEST 28 ST STREET

THE HISTORICAL CARRIAGE HOUSE BUILDING WAS RESTORED AND RELOCATED IN 1978. DURING THIS RELOCATION PROCESS THE EXISTING STONE LEDGE WAS PLACED ON A NEW CONCRETE BLOCK WALL TO CREATE A UTILITY SPACE BELOW.





- CONCRETE
BLOCK WALL
CONSTRUCTED IN
1978 RELOCATION



EXISTING STAIR: TO BE REMOVED





EXISTING RAIL AT FRONT ENTRY




EXISTING STAIR: TO BE REMOVED

PROPOSED BUILDING MODIFICATIONS

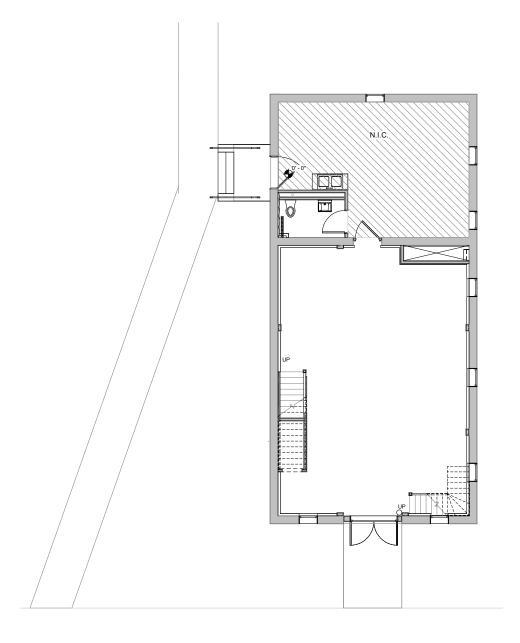

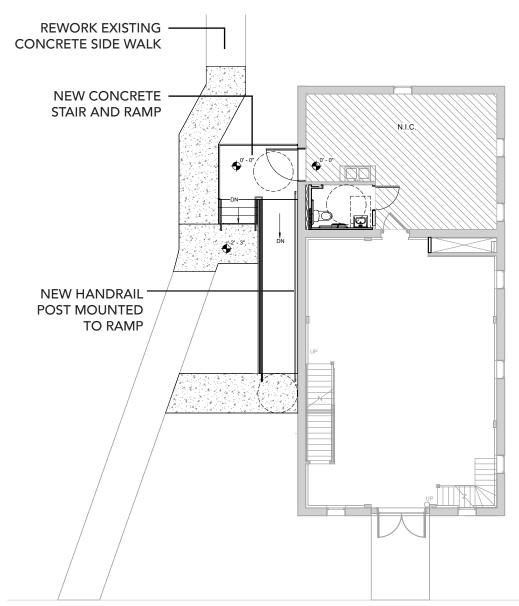

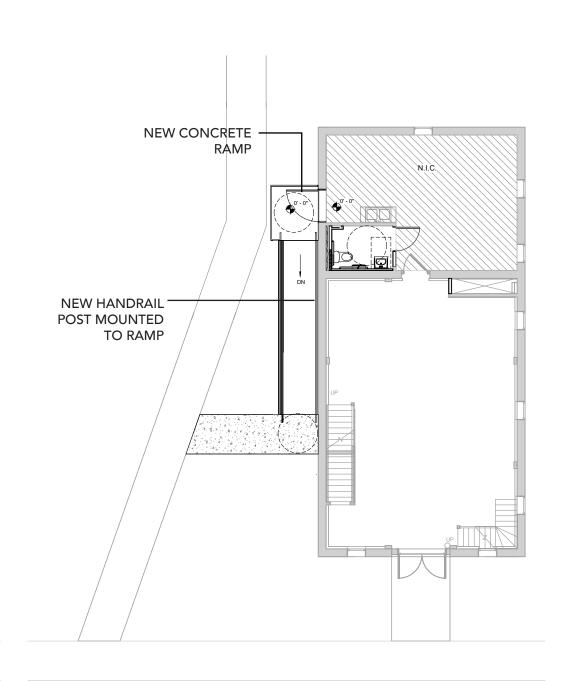


EXISTING CONDITIONS

PROPOSED PLAN

PROPOSED PLAN-ALTERNATE



	EXTERIOR FINISH SCHEDULE		
FINISH TAG	MATERIAL	COLOR	COMMENTS
BR-1	BRICK		EXISTING BRICK TO REMAIN
CMU-1	CONCRETE MASONRY UNIT		EXISTING TO REMAIN
CONC-1	CONCRETE		NEW CONCRETE RAMP AND STAIR
MTL-1	METAL RAIL	BLACK	

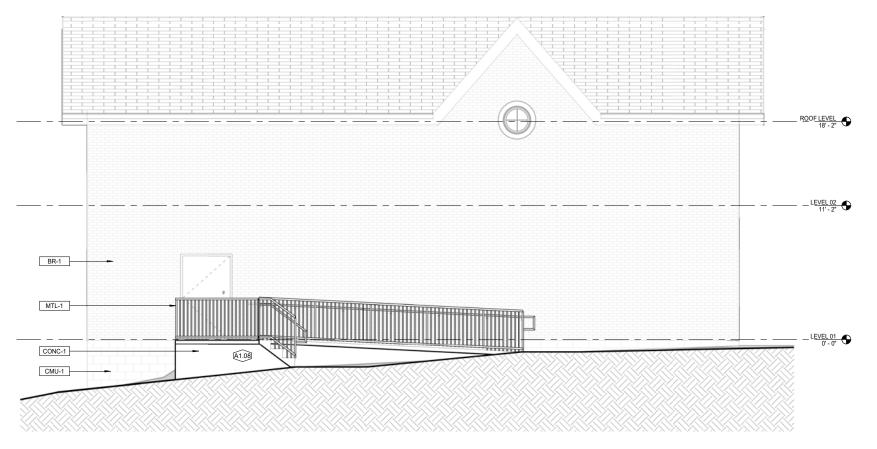

WEST ELEVATION


EXTERIOR LEGEND

Picket Style Rail



Jet Black Powder Coated



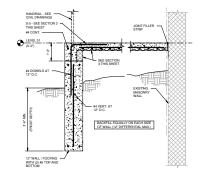

Ramp Detail





LET YOUR SPACES SPEAK.

Design Review



Staff Report



Certificate of Appropriateness

January 26, 2023




Case 23-006: Ohio City Historic District

1904 West 44th Street

Gutter and Porch Replacements

Ward 3: McCormack

Project Representatives: John Alvord, Patrick Nicolino (Owners), Charles Gihla (Civitas Cle)

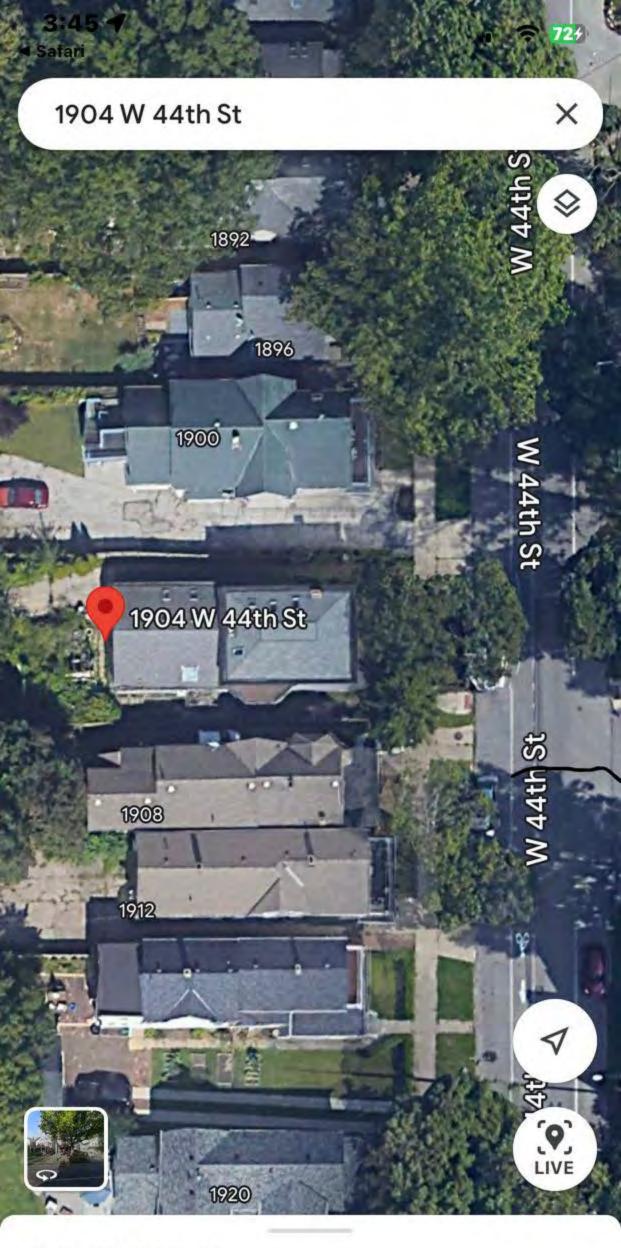

1904 W 44th St

1904 W 44th St, Cleveland, OH 44113



















Building Sketch

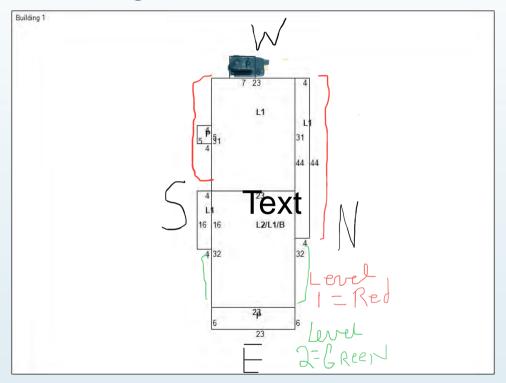


Top View Map

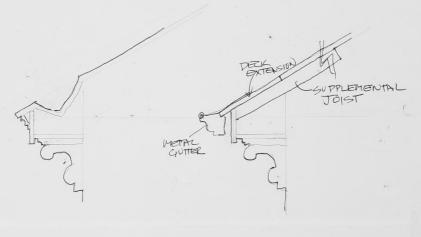



BUGTING BOX GUTTER

PROPOSED METAL GUTTER

2 AUG 32 ALVORD REGIDENCE

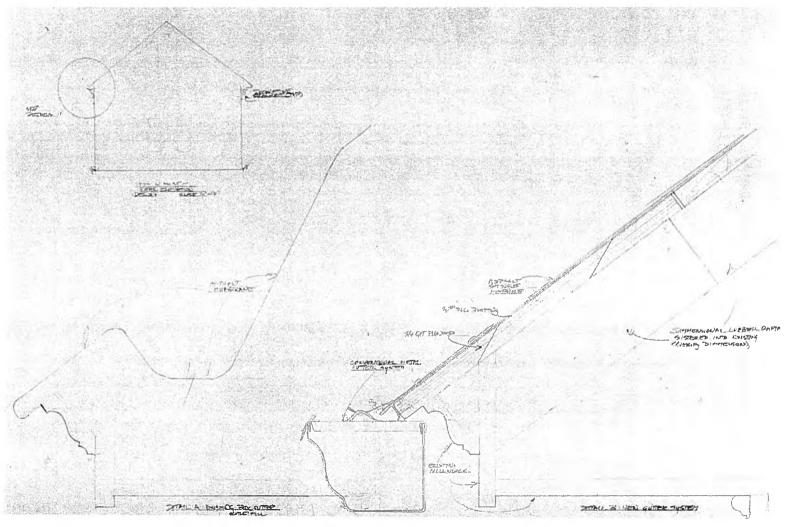

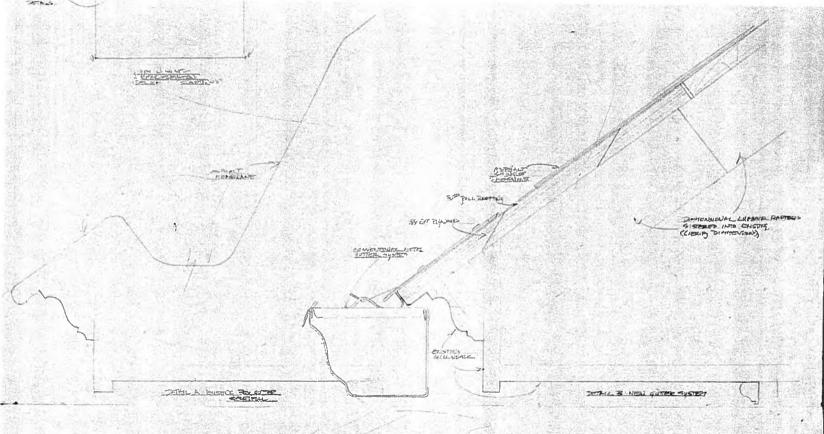


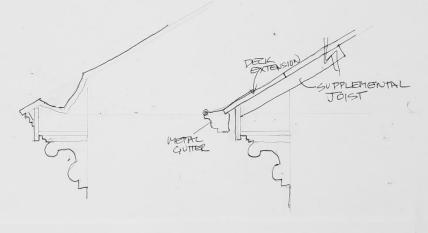

BULLTING BOX GUTTER

PROPOSED METAL GUTTER

2 AUG 32 ALVORD REGIDENCE

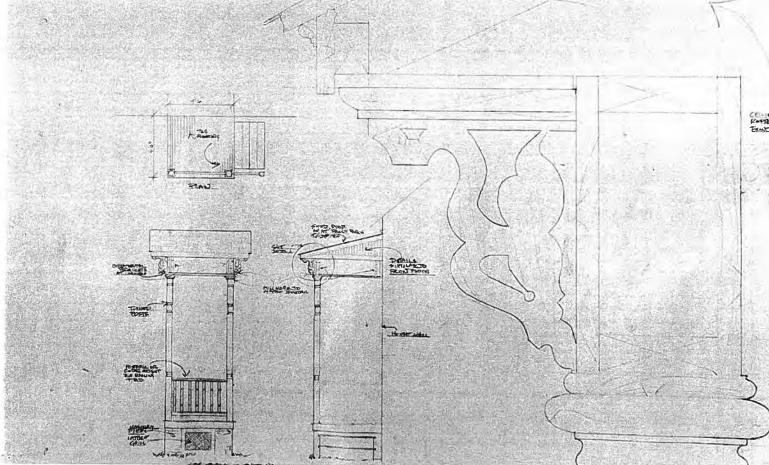

Cleveland Landmarks Commission

Design Review



Cleveland Landmarks Commission

Staff Report



Certificate of Appropriateness

January 26, 2023



Case 23-007: Magnolia-Wade Park Historic District

Wade House Community Engagement Center – 11310 Wade Park Avenue

Renovation and Garage Demolition

Ward 9: Conwell

Project Representatives: Wendy Harbuagh, Joanne Brown, Julian Rogers (Case Western

Reserve University)

Wade House Community Engagement Center


Building Repurposing & Renovation

11310 Wade Park Avenue PPN: 120-19-031

January 26, 2023 City of Cleveland Landmarks Commission Review





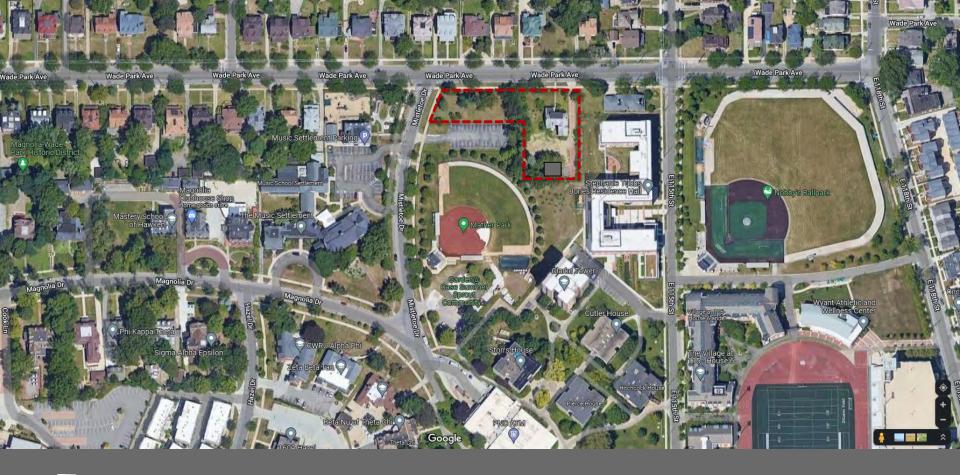



VICINITY PLAN





PRELIM					
you tusted addor consultants architects pleases					
_	\	_		<i> </i>	
COLUMN XXX. BEGINS	(2020)	WATERION	200	200	Male
WILLIAM	CONTRACTO	ALCOID.	OFFICEREDITOR	ORANA ROO	CHECKERO

WADE HOUSE CASE WESTERN RESERVE UNIVERSITY CLEVELAND, OH 44106 -

EXISTING CONDITIONS

190909 LAND
SHEET NAME
EX-1
SHEET OF
1 2





GARAGE GARAGE






GARAGE GARAGE



NORTH FACADE

PROPOSED PROJECT SCOPE:

- 1. Demolish existing garage structure.
- 2. Vacate street (E. 114th Place) and consolidate lot.
- 3. Conditional Use approval for Business.
- 4. Renovate exterior of existing structure.
- 5. Remove second floor porch addition and exterior door at third floor.
- Renovate interior of structure for new community outreach programming.
 Programming includes offices for 4-5 full-time CWRU staff, plus meeting and community spaces.
- 7. New parking lot with lighting.
- 8. New accessibility ramp entrance constructed of composite wood with metal rails & guard.
- 9. New landscaping.

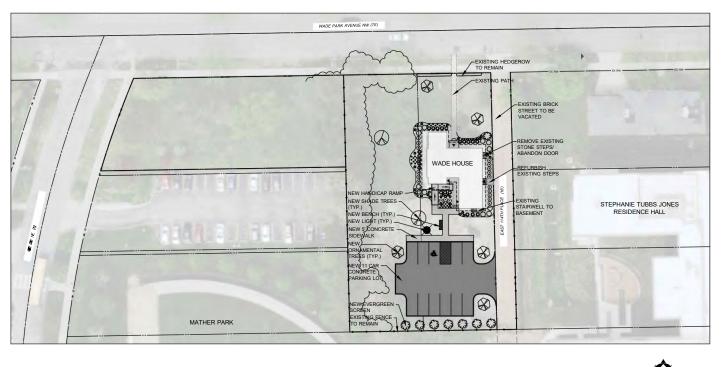









2 2

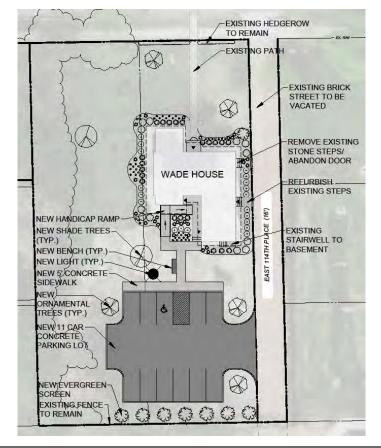

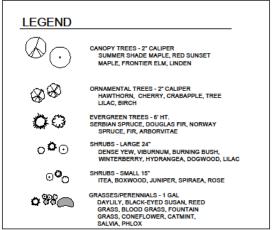



Replace existing roof.

Install new gutters & downspouts and new exterior lighting.

 Remove second floor porch addition and exterior door at third floor.

New exterior lighting.


 Replace all windows with metal clad exterior, interior wood windows, double-hung and white.

Paint existing trim to match window frame color.

Add new landscaping.

NORTH FACADE




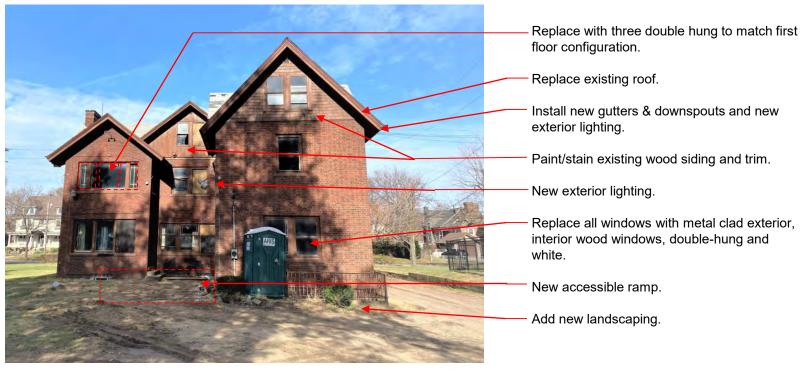


SOUTH FACADE



EAST FACADE

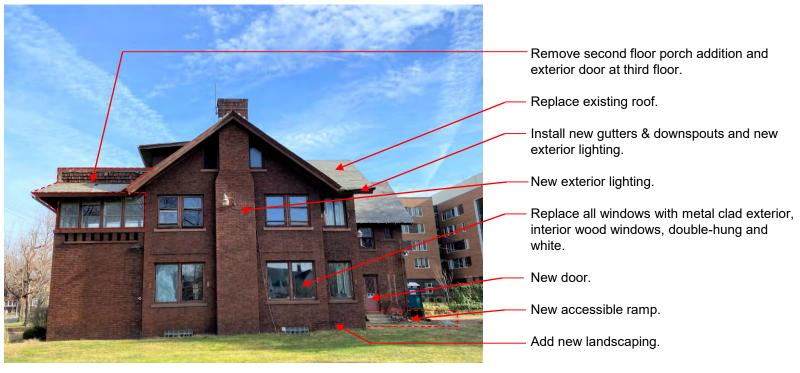



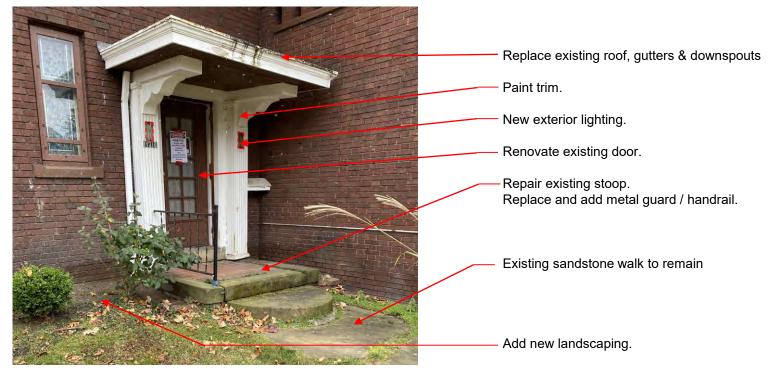

NORTH ENTRANCE & STOOP



1960s COUNTY ARCHIVE NO UPPER ENCLOSURE



1980s ARCHIVE



ORIGINAL ROOF FRAMING



ORIGINAL ROOF FRAMING



2ND FLOOR PORCH CEILING/ROOF FRAMING



2ND FLOOR PORCH CEILING/ROOF FRAMING





RENDERING - PROPOSED EXTERIOR IMPROVEMENTS





RENDERING - PROPOSED EXTERIOR IMPROVEMENTS



STEPHANIE TUBBS JONES RESIDENCE HALL



STEPHANIE TUBBS JONES RESIDENCE HALL



CWRU SUSTAINABILITY HOUSE



CWRU SUSTAINABILITY HOUSE & STJ RESIDENCE HALL




WADE PARK AVE. (ACROSS STREET)



WADE PARK AVE. (ACROSS STREET)



WADE PARK AVE. (ACROSS STREET)

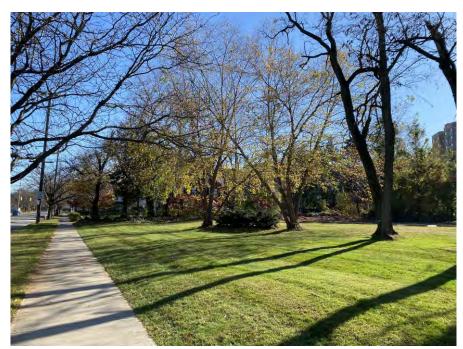

WADE PARK AVE. (CORNER PROPERTY)



BRICK & WHITE TRIM (E. 115th STREET)



BRICK & WHITE TRIM (E. 115th STREET)



MUSIC SETTLEMENT PARKING



CWRU MATHER SOFTBALL PARK



PROPOSED PROJECT SCOPE:

- 1. Demolish existing garage structure.
- 2. Vacate street (E. 114th Place) and consolidate lot.
- 3. Conditional Use approval for Business.
- 4. Renovate exterior of existing structure.
- 5. Remove second floor porch addition and exterior door at third floor.
- Renovate interior of structure for new community outreach programming.
 Programming includes offices for 4-5 full-time CWRU staff, plus meeting and community spaces.
- 7. New parking lot with lighting.
- 8. New accessibility ramp entrance constructed of composite wood with metal rails & guard.
- 9. New landscaping.

Design Review





Magnolia-Wade Park-Grantwood Allotments Design Review Committee Certificate of Appropriateness Review

File Number: NE22-02

Date: 12/15/2022

Building / Project Name: Wade Park Renovation

Property Address: 11310 Wade Park Drive					
Property Owner: Case Western Reserve University					
Historic Designation: \square National Register $\ oxtimes$ Local Landmarks District $\ oxtimes$ Landmark Building					
Presenters: Wendy Harbaugh, Julian Rogers, Joanne Brown					
Specifications of work proposed:					
Demolish existing garage – roof collapse and unstable					
Renovate main house for community space – remove second floor enclosed balcony and add ramp to rear					
Vacate adjoining street and update landscaping					
Recommendations of Design Review Committee:					
Recommend approval for demolition of garage; return with intent on preservation for renovations on home					
Notes/Comments:					
Frustration noted by Committee members on state of home and disrepair; concern on removing a residential-appearing					
building to be non-residential and removal of historic elements; comments on possibility to keep garage and restore or					
maintain part of the structure; concern on necessity to remove second floor enclosed balcony and evidence requested					
for original v. later addition					
Design Review Committee:					
Marc Baniszewski ⊠ Not Present □ In-Favor □ Opposed □ Table □ Abstain/Recuse					
leff Johnson □ Not Present ⊠ In-Favor □ Opposed □ Table □ Abstain/Recuse					
Lashanna Lawler \square Not Present \square In-Favor \boxtimes Opposed \square Table \square Abstain/Recuse					
Lothario Marchmon \square Not Present \boxtimes In-Favor \square Opposed \square Table \square Abstain/Recuse					
Matt Provolt ☐ Not Present ☒ In-Favor ☐ Opposed ☐ Table ☐ Abstain/Recuse					
Ava Schmidt ☐ Not Present ☒ In-Favor ☐ Opposed ☐ Table ☐ Abstain/Recuse					
Arleesha Wilson ☑ Not Present □ In-Favor □ Opposed □ Table □ Abstain/Recuse					
Rob Norton ☐ Not Present ☒ In-Favor ☐ Opposed ☐ Table ☐ Abstain/Recuse					
Non-Voting In Attendance Jessica Beam, Dan Musson					
Required to present at Cleveland Landmarks Commission? Yes No Date:					



Magnolia-Wade Park-East Blvd-Grantwood Allotments Design Review Committee Certificate of Appropriateness Review

File Number: NE22-02

Date: 1/19/2023

Building / Project Nam	e: Wade Park Renovation			
Property Address: 113	10 Wade Park Drive			
Property Owner: Case	Western Reserve University			
Historic Designation:	\square National Register $\ oxtimes$ Local Landmarks District $\ oxtimes$ Landmark Building			
Presenters: Wendy Hai	rbaugh, Julian Rogers, Joanne Brown			
Specifications of wor	k proposed:			
restore walkout balcon	tuckpointing, new windows, paint existing trim, remove existing second floor enclosed porch and y. Landscaping and other improvements to return at a later date			
Recommendations o	f Design Review Committee:			
landscaping and other	of exterior changes to home with condition on changes to east façade door returning. Future changes to return in the future			
Notes/Comments:				
	terns for the future street vacating and care/maintenance of current brick street; retaining the			
	e important and ensured. The Committee noted frustrations for work not beginning when Case			
	years ago. Committee commented on the positive changes to the home and discussed the			
	he east façade – options proposed include removing stairs but keeping door, infilling with window			
and retaining wood aw	rning, not in favor of complete removal and infill.			
Design Review Comn	nittee:			
Marc Baniszewski	$oximes$ Not Present \omin In-Favor \omin Opposed \omin Table \omin Abstain/Recuse			
Jeff Johnson	\square Not Present $\ \boxtimes 1$ In-Favor $\ \square$ Opposed $\ \square$ Table $\ \square$ Abstain/Recuse			
Lashanna Lawler	oximes Not Present $oximes$ In-Favor $oximes$ Opposed $oximes$ Table $oximes$ Abstain/Recuse			
Lothario Marchmon	\square Not Present $\ \boxtimes$ 2 In-Favor $\ \square$ Opposed $\ \square$ Table $\ \square$ Abstain/Recuse			
Matt Provolt	\square Not Present \boxtimes In-Favor \square Opposed \square Table \square Abstain/Recuse			
Ava Schmidt	\square Not Present $\ \boxtimes$ In-Favor $\ \square$ Opposed $\ \square$ Table $\ \square$ Abstain/Recuse			
Arleesha Wilson	oximes Not Present $oximes$ In-Favor $oximes$ Opposed $oximes$ Table $oximes$ Abstain/Recuse			
Rob Norton	\square Not Present $\ \boxtimes$ In-Favor $\ \square$ Opposed $\ \square$ Table $\ \square$ Abstain/Recuse			
Non-Voting In Attendance Jessica Beam, Dan Musson				
Required to present at	Cleveland Landmarks Commission? ⊠Yes □ No Date: 1/26/2023			

Staff Report



Concept Plan



Concept Plan

January 26, 2023



Case 23-008: Ohio City Historic District

2905 Jay Avenue


New Construction

Ward 3: McCormack

Project Representatives: Chris Rood (Architect)

WOLLENHAUPT CONCEPTUAL DESIGN


WEST 29TH AND JAY AVE. JANUARY 26, 2023

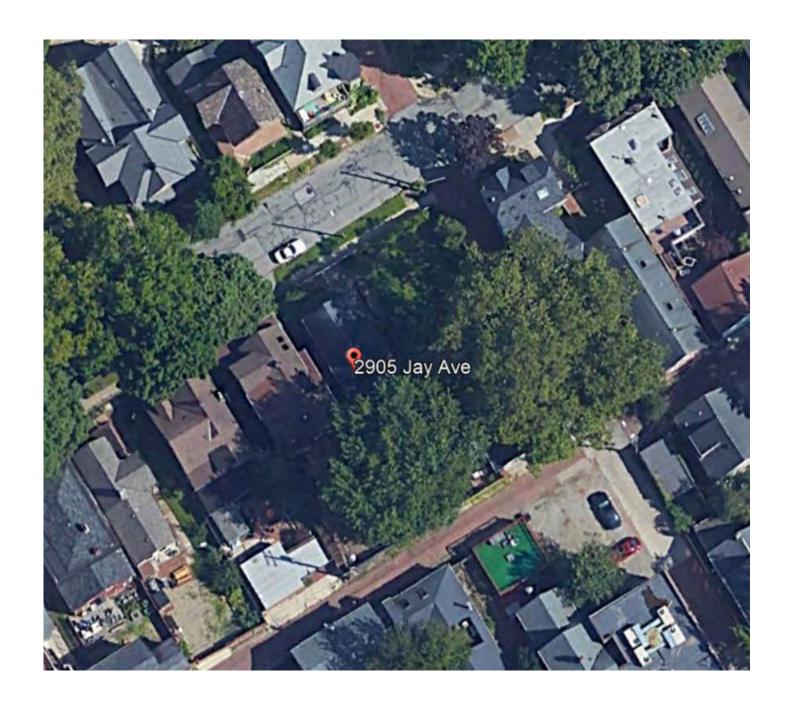



SITE AERIAL PARCEL AERIAL



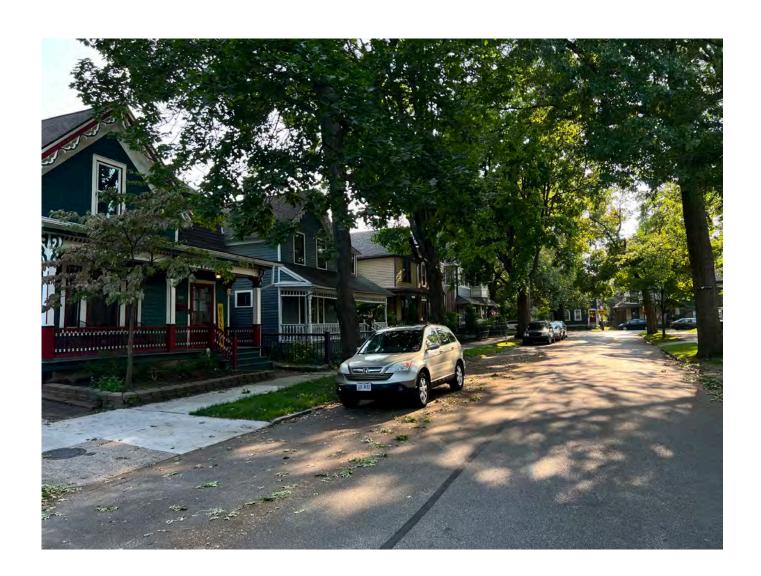







Proposed Site Plan | Conceptual Design



Proposed Plans | Conceptual Design

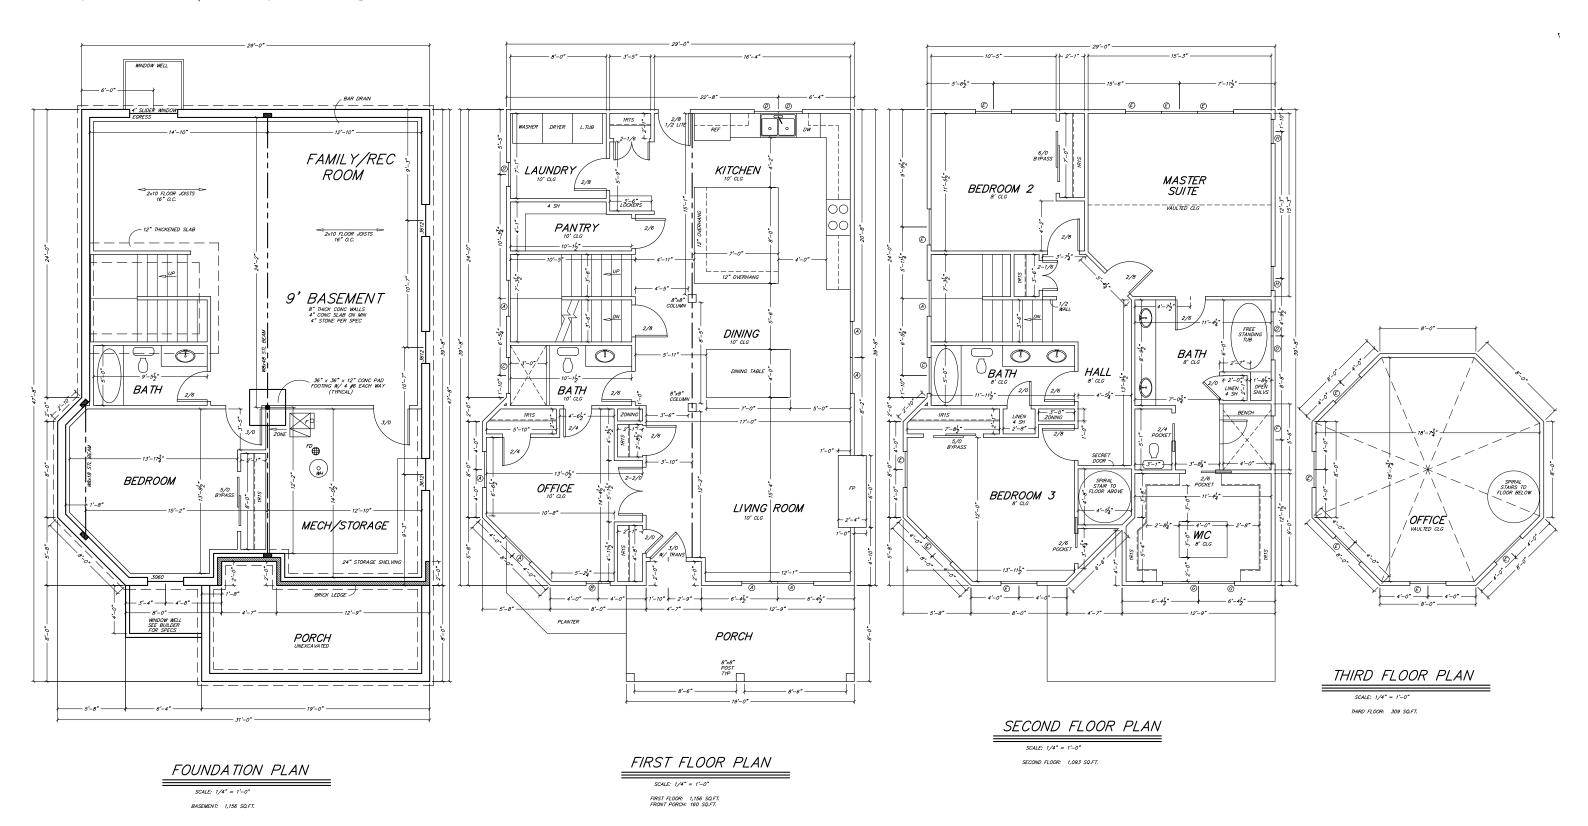


Material Palette | Conceptual Design

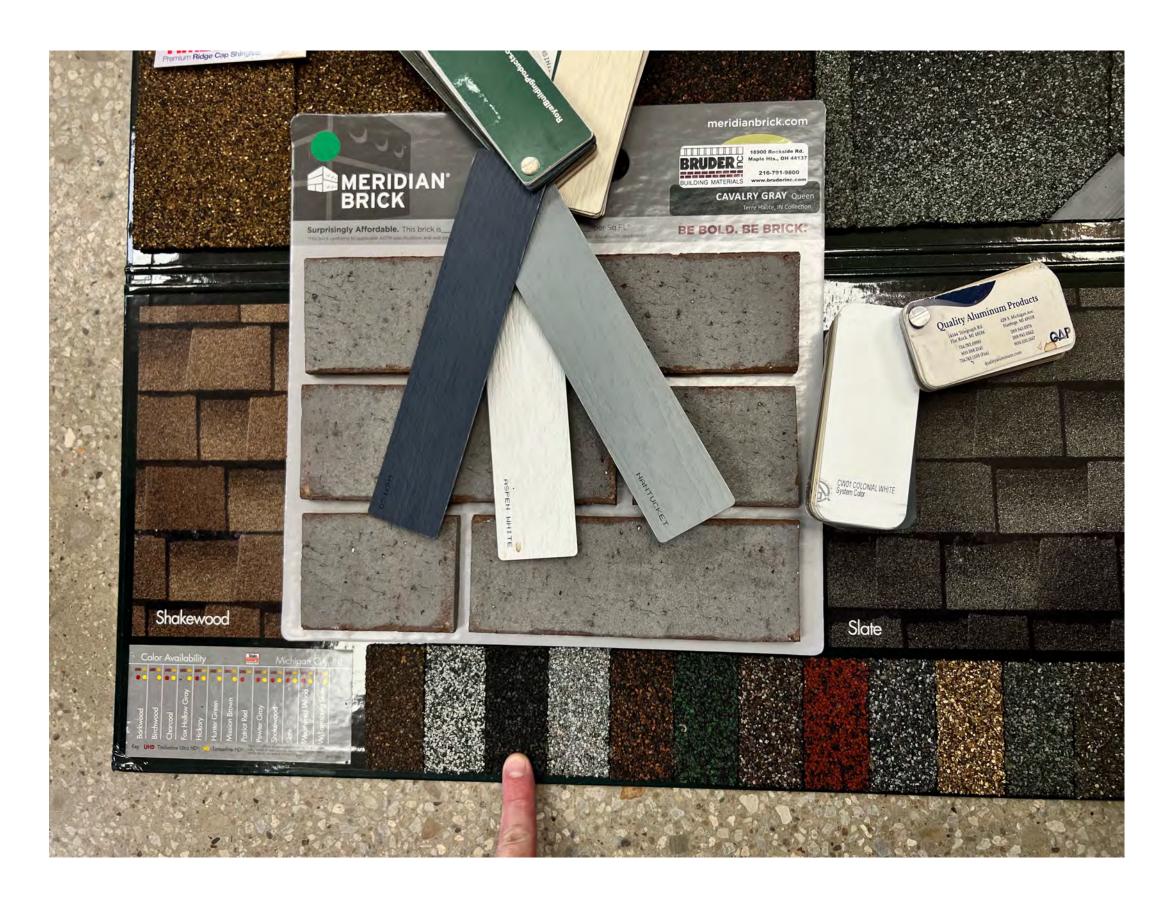



Material Palette:

- -Primary Siding: Indigo Blue
- -Accent Siding: Nantucket Gray
- -Trim, Gutters & Soffits/Fascia: White
- -Brick: Cavalry Gray
- -Asphalt Roof Shingles: Black

Proposed Elevations | Conceptual Design

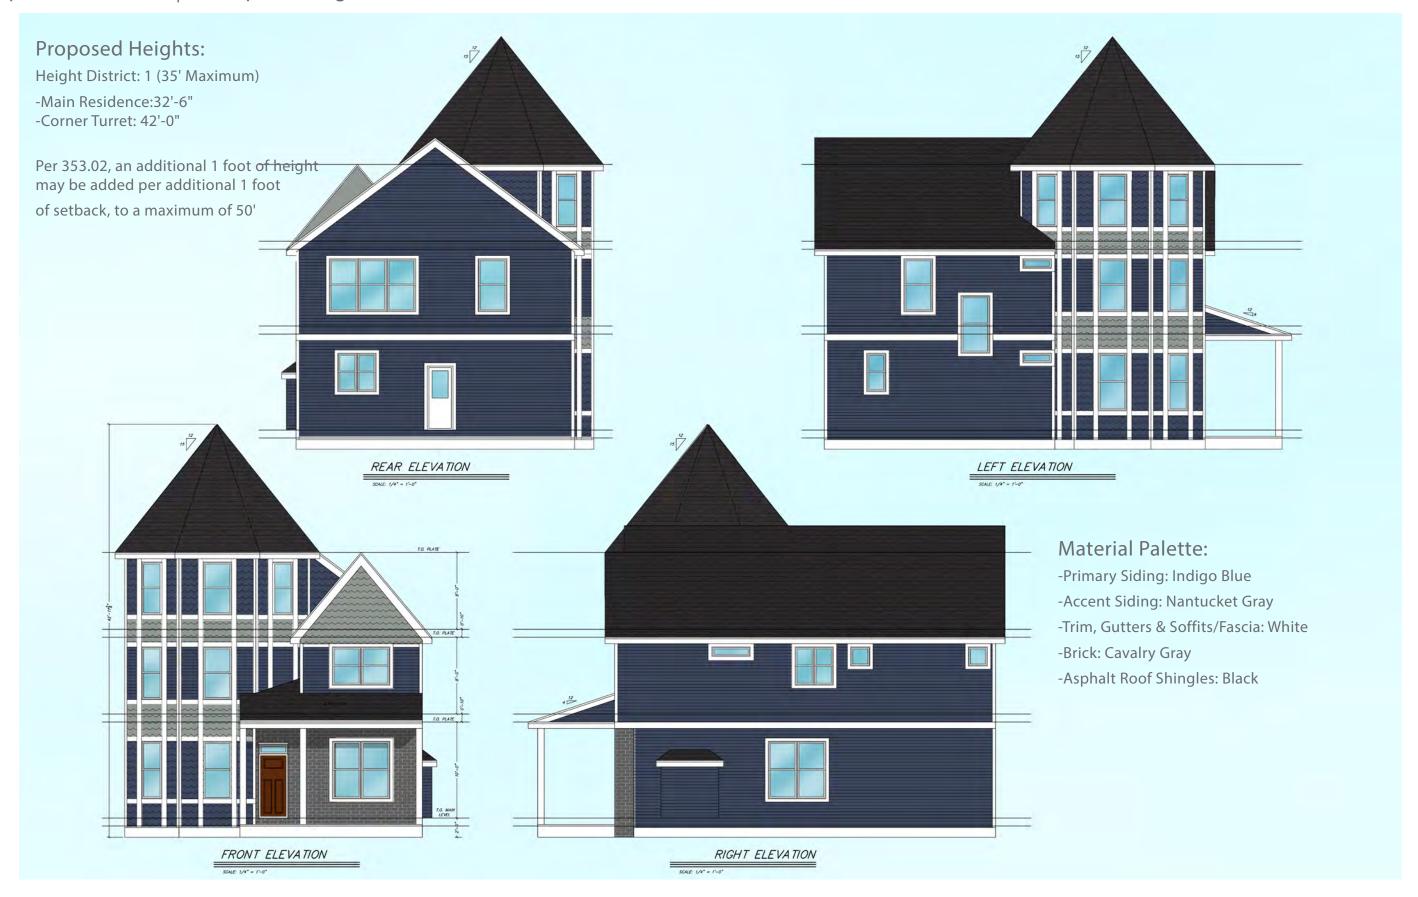


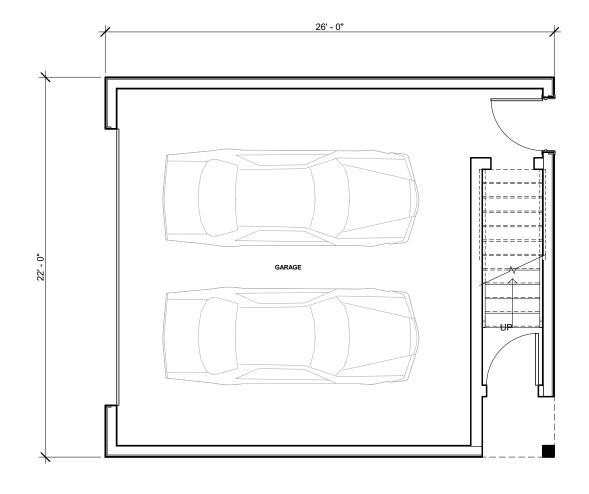


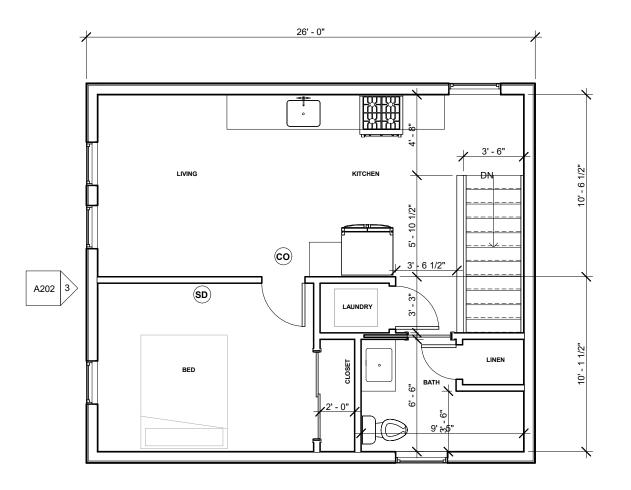


LEVEL ONE GARAGE PLAN

LEVEL TWO GARAGE PLAN

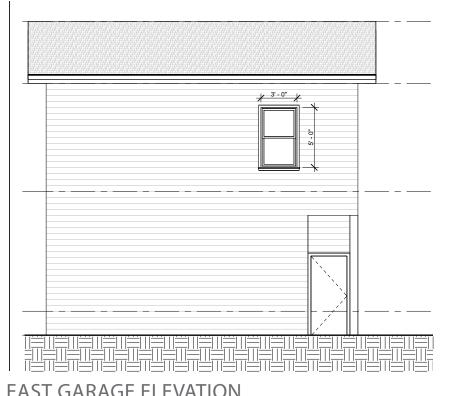

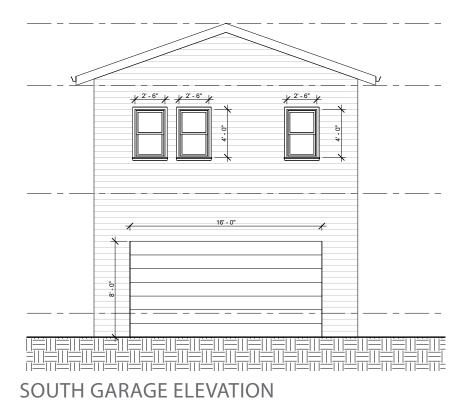

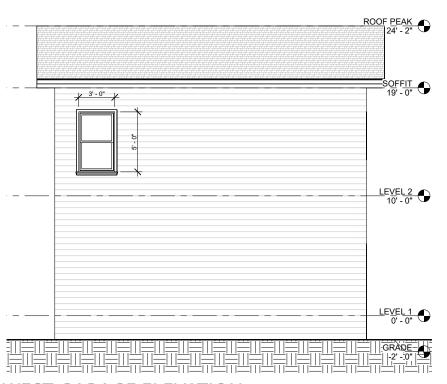

EAST GARAGE ELEVATION

WEST GARAGE ELEVATION

NOTE: GARAGE MATERIALS TO MATCH **NEW RESIDENCE**

Design Review




Ohio City Historic District Design Review Committee

(Advisory committee to the Landmarks Commission) **Certificate of Appropriateness Review**

Date : 12-01-22	<u>File Number:</u>
Building / Project Nam	e: 2905 Jay Ave New Construction
Property Address : 2905	5 Jay Ave Parcel #:
Property Owner: Prese	
Historic Designation:	□ Not Designated ⊠ Local Landmarks District □ Landmark Building
Specifications of wor	k proposed:
New Construction of	single-family home - Conceptual
Recommendations of	f Design Review Committee:
No action taken	
Notes/Comments	
The turret is overriding	the house (too substantial), needs scaled down. Brick portion on front - would be better
continue the same mat	eriality. Design needs balance overall – CL. Color palette is fine. Shallow pitch needed -AM. 3
different roof lines, diff	icult to dry when wet. Trim detailing neeed – ML.
Design Review Commit	tee Record:
Alex Frondorf	☐ Not Present ☐ In-Favor ☐ Opposed ☐ Table ☐ Abstain
Antonia Marinucci	□ Not Present □ In-Favor □ Opposed □ Table □ Abstain
Doug Wahl	\square Not Present \square In-Favor \square Opposed \square Table \square Abstain
Margaret Lann	\square Not Present \square In-Favor \square Opposed \square Table \square Abstain
Chris Loeser	\square Not Present \square In-Favor \square Opposed \square Table \square Abstain
Marika Shiori-Clark	\square Not Present \square In-Favor \square Opposed \square Table \square Abstain

Staff Report



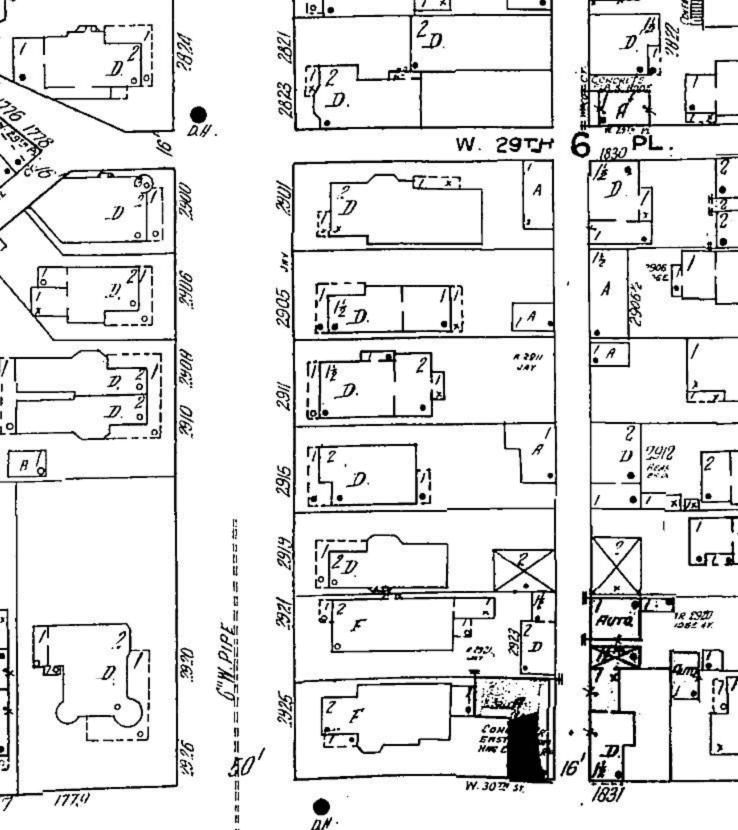

January 26, 2023



Case 23-009: Newton Avenue Historic District


Gordon Crossing – East 101st Street, Woodward Avenue, and Newton Avenue

New Construction

Ward 7: Howse

Project Representatives: Jonathan McKay (Woda Cooper Companies, Inc.)

GORDON CROSSING

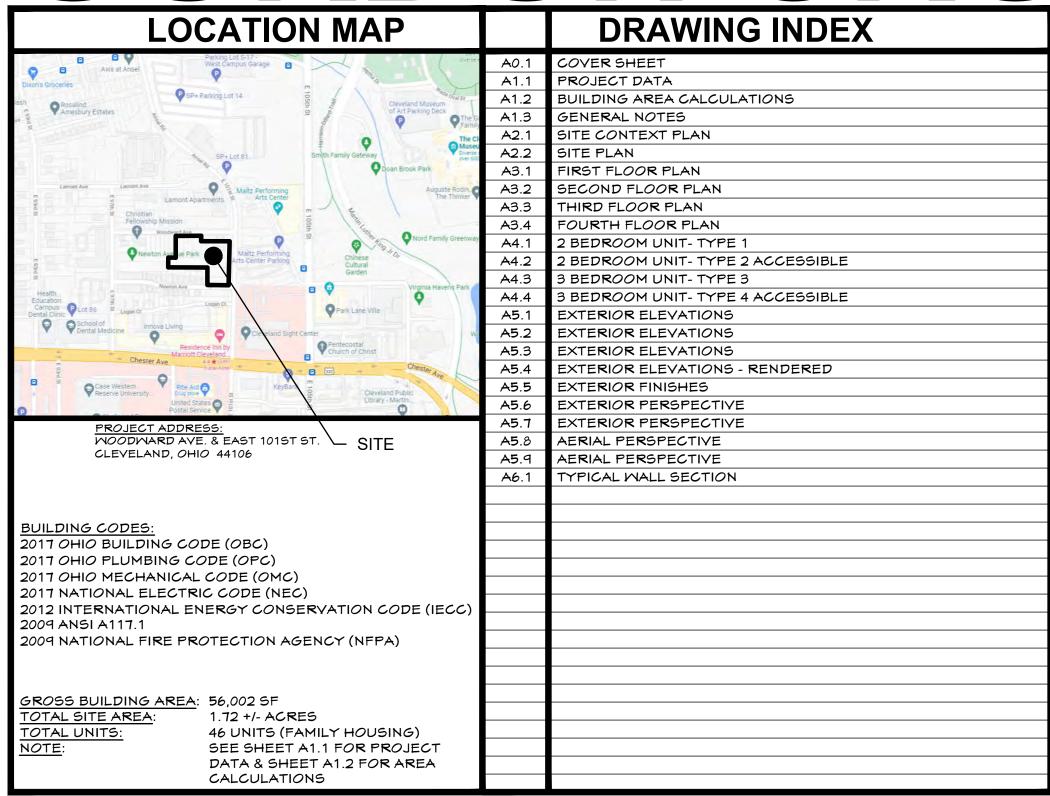

CLEVELAND, OHIO **CUYAHOGA COUNTY**

FAMILY HOUSING

DEVELOPER

WODA COOPER DEVELOPMENT, INC.

DEVELOPER

FRONTLINE DEVELOPMENT GROUP, LLC

ARCHITECT

PCI DESIGN GROUP, INC.

OWNER

GORDON CROSSING LIMITED PARTNERSHIP

CONTRACTOR

WODA CONSTRUCTION, INC.

MANAGEMENT

WODA MANAGEMENT & REAL ESTATE, LLC

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PCI DESIGN GROUP, INC. 500 SOUTH FRONT STREET SUITE 975





Photo 1: Southeasterly view at the soil pile and residential debris on the north central portion of the property.



Photo 2: Northerly view at the soil pile and overhead powerlines on the central portion of the property.





Photo 3: Viewing at construction materials observed on the southern portion of the property.



Photo 4: Easterly view across the central portion of the property.





Photo 5: Northwesterly view across the east portion of the property.



Photo 6: Southerly view across the west portion of the property.





Photo 7: Viewing at the north adjoining multi-tenant residential building.



Photo 8: Viewing at the west adjoining vacant land and house.





Photo 9: Viewing at one of the south adjoining houses.



Photo 10: Viewing at the south adjoining office building and parking garage.





Photo 11: Viewing at the east adjoining Performing Arts Center.



Photo 12: Viewing at the east adjoining parking lot.



SITE DI	EVELOPMENT DATA
ADDRESS:	MOODWARD AVE. & EAST 101ST ST.
	CLEVELAND, OH 44106
PARCEL ID:	11912058
SITE AREA:	1.72 ACRES +/-
ZONING:	
CURRENT	MF-E2
PROPOSED	MF-E2
HEIGHT DISTRICT:	
PROPOSED USE:	MULTI-FAMILY RESIDENTIAL
DENSITY:	27 UNITS/ACRE +/-
PARKING:	TOTAL PROVIDED - 42 SPACES
SETBACKS:	AS SHOWN
HEIGHT OF BUILDING:	34'-7 5/8" +/-

RESIDENTIAL UNIT DATA								
UNIT								TOTAL
TYPE	UNIT	NET	GROSS	15T	2ND	3RD	4TH	UNIT
		AREA (SF)	AREA (SF)	FLOOR	FLOOR	FLOOR	FLOOR	
1	2 BEDROOM ANSI TYPE B	823	877	6	8	9	8	31
2	2 BEDROOM ANSI TYPE A - ACCESSIBLE	823	877	1	1	0	1	3
3	3 BEDROOM ANSI TYPE B	1,101	1,167	2	3	2	3	10
4	3 BEDROOM ANSI TYPE A - ACCESSIBLE	1,101	1,167	1	0	1	0	2
·								
			T <i>O</i> TAL	10	12	12	12	46

*NOTE: (1) 2 BEDROOM TYPE 1 UNIT IS DESIGNATED AS A SIGHT AND HEARING UNIT (SENSORY 504)


STATE	BLIII	DING	CODE	- 2017	OBC.
	שוטע	ייוע		- 20 1 1	

USE GROUP: R-2 RESIDENTIAL (FAMILY OCCUPANCY) CONSTRUCT. TYPE: 5A SLAB ON GRADE, WOOD FRAME



BUILDING AREA CALCULATIONS						
	15T FL <i>OOR</i>	2ND FLOOR	3RD FLOOR	4TH FLOOR	TOTAL	
GROSS SQUARE FOOTAGE OF BUILDING	14,263	13,913	13,913	13,913	56,002	
COMMERCIAL SPACE CONDOMINIUM AREAS	0	0	0	0	0	
COMMERCIAL AREAS AND FEE-DRIVEN SPACES	0	0	0	0	0	
MARKET RATE UNIT AREA	0	0	0	0	0	
LOW INCOME UNIT AREA	9,640	11,394	11,394	11,394	43,822	
MANAGER'S UNIT AREA	0	0	0	0	0	
COMMON AREA (PUBLIC)	1,557	244	244	244	2,289	
COMMON AREA (CIRCULATION)	1,723	1,359	1,359	1,359	5,800	
COMMON AREA (SOCIAL WORK/PROGRAMATIC)	172	0	0	0	172	
LIMITED COMMON AREA (PRIVATE)	0	0	0	0	0	
SUPPORT	590	349	349	349	1,637	
TENANT STORAGE	0	0	0	0	0	
MAJOR VERTICAL PENETRATIONS	556	556	556	556	2,224	
STRUCTURED PARKING/GARAGE	0	0	0	0	0	
BASEMENT	0	0	0	0	0	
NON-LOW-INCOME FLOOR AREA	0				0	
LOW INCOME FLOOR AREA 49,622						
PERCENTAGE OF COMMON AREA 14.44%						
NET RENTABLE SQUARE FOOTAGE						
AVG. NET RENTABLE SQ-FT/LOW INCOME UNIT					1,217.44	



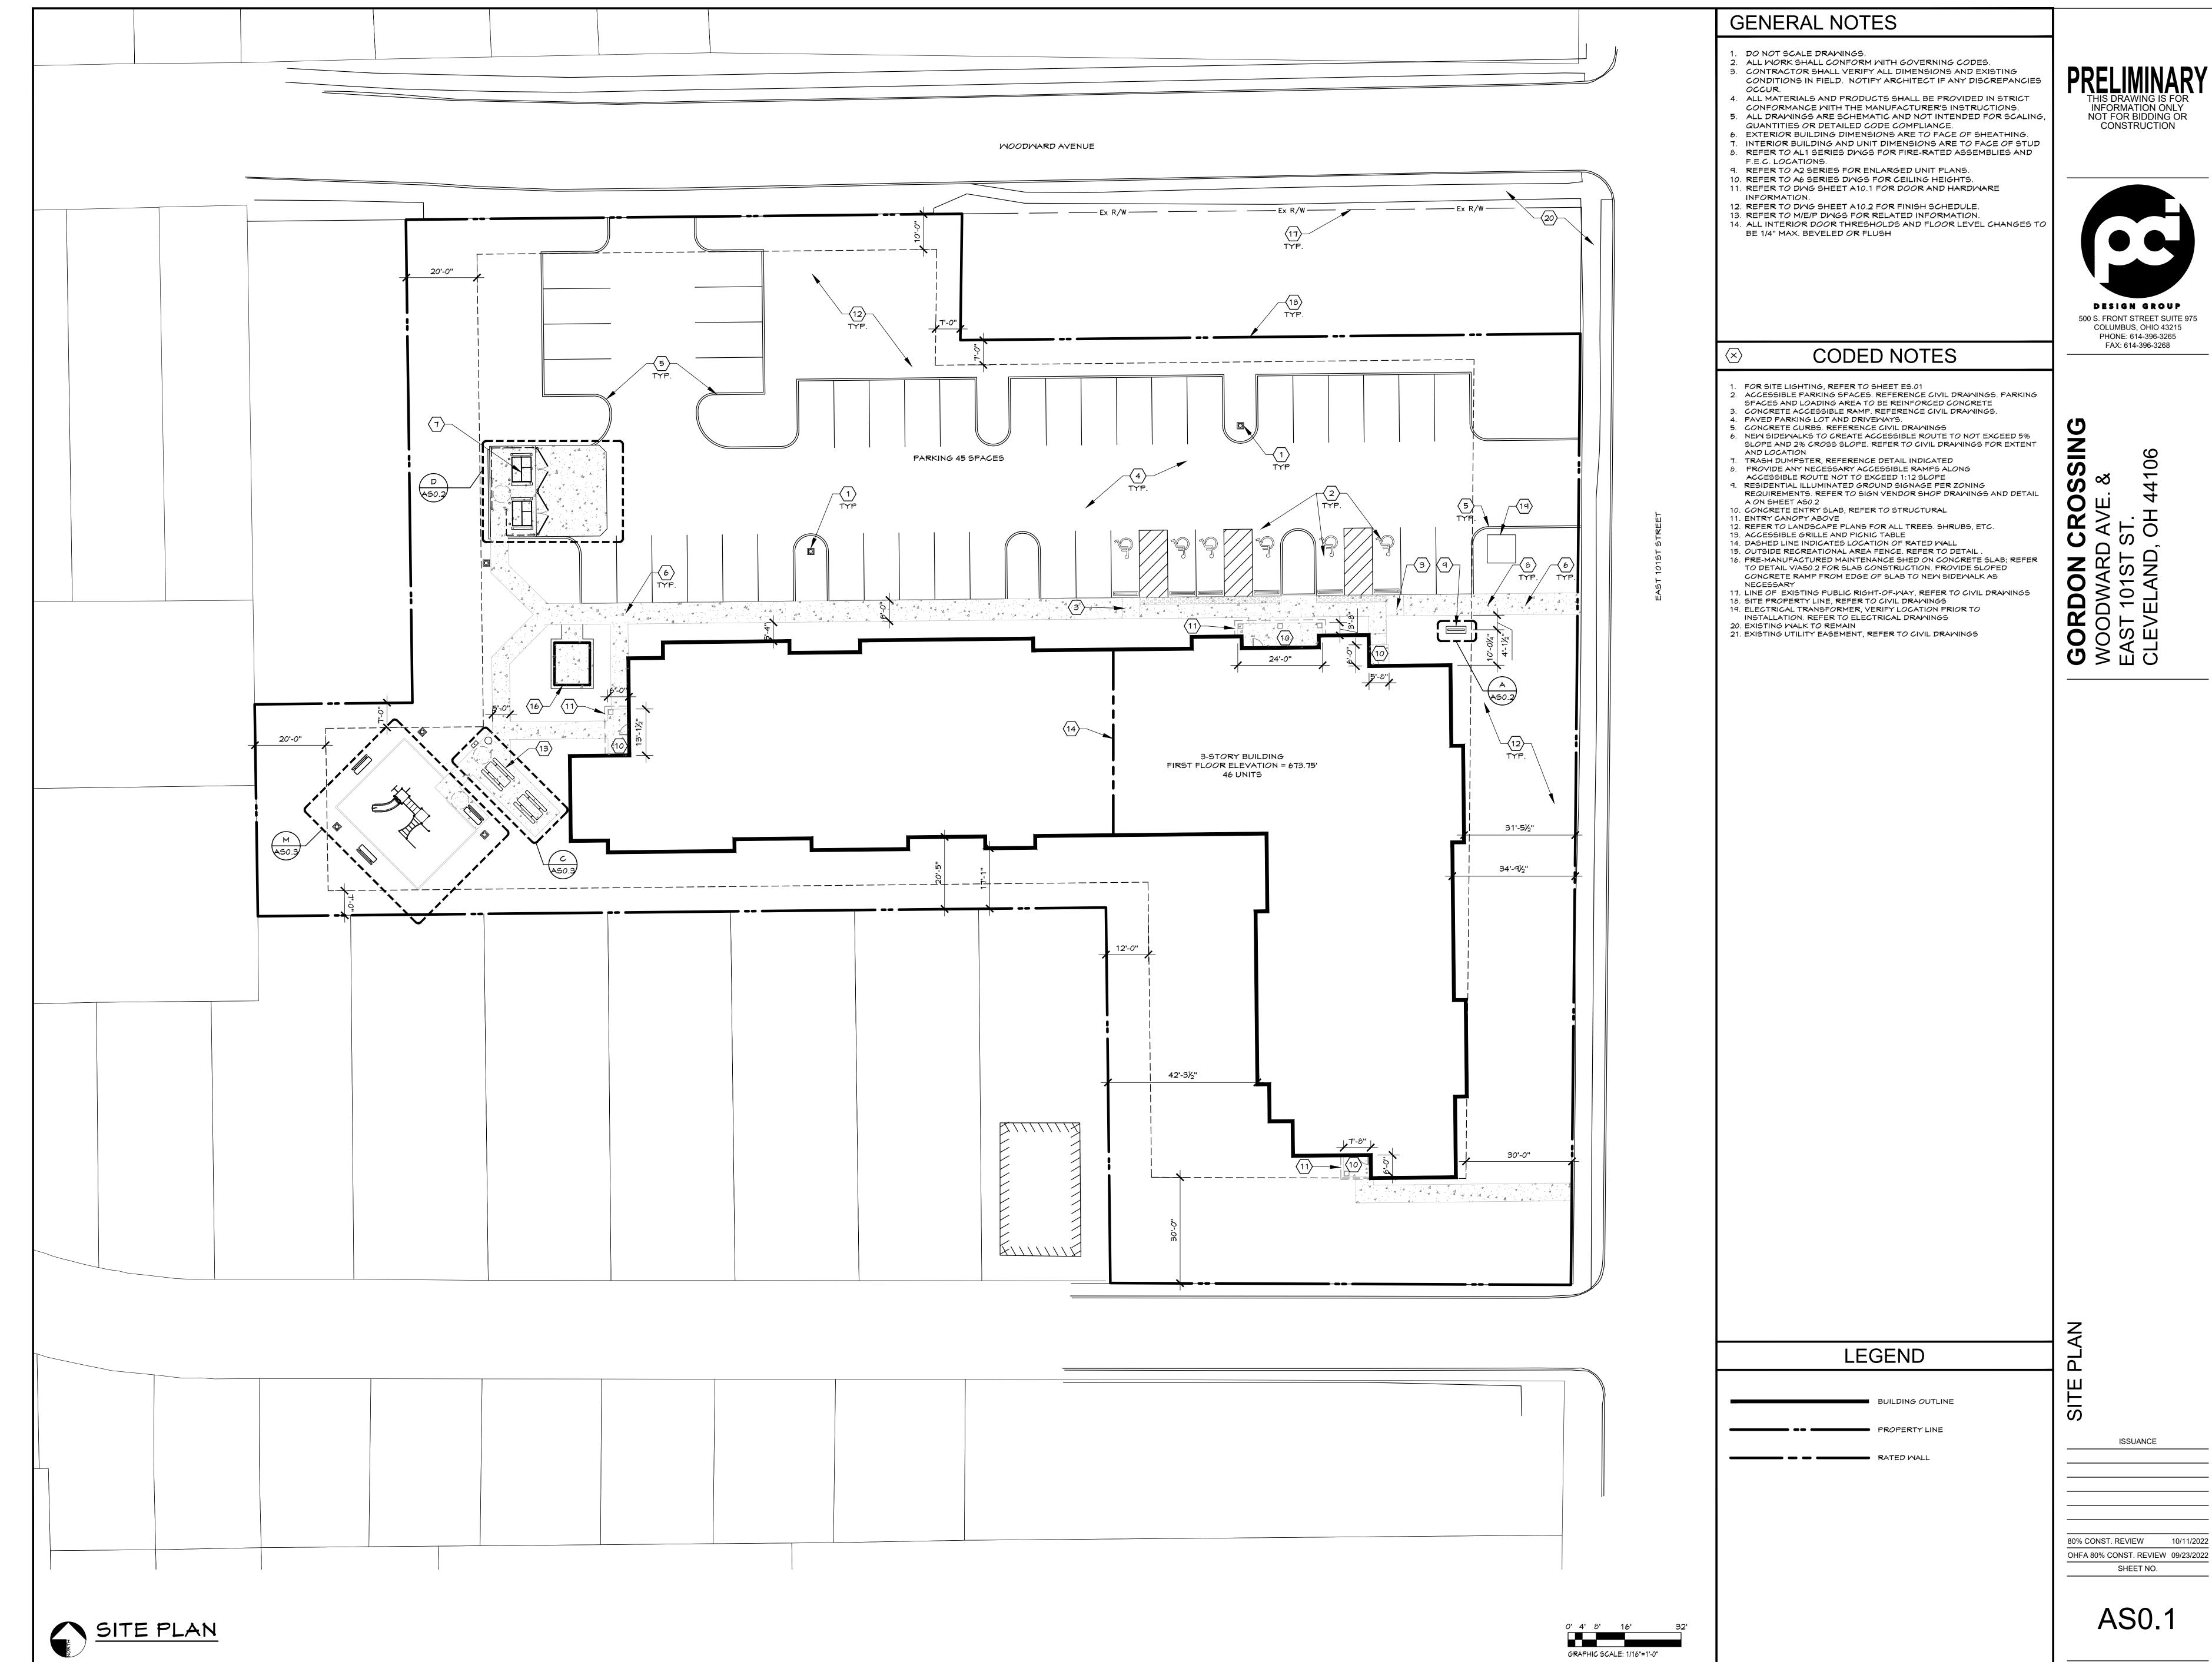



OHFA 80% CONST. REVIEW 09/23/2022

JOB NUMBER: WOD267



SOUTH ELEVATION

GENERAL NOTES

- 1. DO NOT SCALE DRAWINGS. 2. ALL WORK SHALL CONFORM WITH GOVERNING CODES. 3. CONTRACTOR SHALL VERIFY ALL DIMENSIONS AND EXISTING
- CONDITIONS IN FIELD. NOTIFY ARCHITECT IF ANY DISCREPANCIES 4. ALL MATERIALS AND PRODUCTS SHALL BE PROVIDED IN STRICT
- CONFORMANCE WITH THE MANUFACTURER'S INSTRUCTIONS. 5. ALL DRAWINGS ARE SCHEMATIC AND NOT INTENDED FOR SCALING,
- QUANTITIES OR DETAILED CODE COMPLIANCE. 6. EXTERIOR BUILDING DIMENSIONS ARE TO FACE OF SHEATHING.
- 7. INTERIOR BUILDING AND UNIT DIMENSIONS ARE TO FACE OF STUD 8. REFER TO AL1 SERIES DWGS FOR FIRE-RATED ASSEMBLIES AND F.E.C. LOCATIONS. 9. REFER TO A2 SERIES FOR ENLARGED UNIT PLANS
- 11. REFER TO DWG SHEET A10.1 FOR DOOR AND HARDWARE INFORMATION. 12. REFER TO DWG SHEET A10.2 FOR FINISH SCHEDULE. 13. REFER TO M/E/P DWGS FOR RELATED INFORMATION.
- 14. ALL INTERIOR DOOR THRESHOLDS AND FLOOR LEVEL CHANGES TO BE 1/4" MAX. BEVELED OR FLUSH

THIS DRAWING IS FOR INFORMATION ONLY NOT FOR BIDDING OR CONSTRUCTION



SIN

CRO D AVE.

GORDON
WOODWARE
EAST 101ST
CLEVELAND

CODED NOTES

- MODULAR FACE BRICK BRICK ROWLOCK COURSE
- PRE-FINISHED FIBER CEMENT PANEL
- PRE-FINISHED FIBER CEMENT TRIM 5. 12" × 6" PRE-FINISHED ALUMINUM SCUPPER. REFER TO
- DETAIL U/A7.2 OVERFLOW SCUPPER. REFER TO DETAIL S/A7.2.
- HORIZONTAL DUTCH LAP VINYL SIDING ENERGY STAR-RATED VINYL WINDOW; REFER TO MINDOM SCHEDULE.
- VINYL TRIM
- 10. REINFORCED CONCRETE SLAB11. ENERGY STAR RATED DOOR; REFER TO DOOR SCHEDULE. 12. PORCH CANOPY
- 13. HIGH-VISIBILITY ADDRESS NUMBERS AT ENTRY 14. PRE-FINISHED ALUMINUM DOWNSPOUT. PROVIDE BEST CONNECTION ABOVE GRADE AND TIE INTO PVC
- BOOT. REFER TO CIVIL DRAWINGS. 15. PRE-FINISHED WALL LOUVER; REFER TO MECHANICAL DRAWINGS
- VERTICAL VINYL SIDING 17. BRICK SOLDIER COURSE
- 19. FREEZE-PROOF LOCKING HOSE BIB; REFER TO
- PLUMBING DRAWINGS 20. EXTERIOR WALL-MOUNTED LIGHTING FIXTURE; SEE ELECTRICAL DRAWINGS
- DRAWINGS 22. HATCHED AREA INDICATES LOCATION OF 4'-0" FIRE RETARDANT TREATED EXTERIOR SHEATHING AT FIRE
- 23. METAL COPING
- 25. FIBER CEMENT TRIM AND CORNICE 26. EXTERIOR SIGNAGE 27. ELEVATOR SHAFT

SYMBOLS

GRAPHIC SCALE:1/8"=1'-0"

REFER TO OWNER SELECTION SCHEDULE O	ŹΝ
SHEET A10.2 FOR ADDITIONAL INFORMATION	N

COPING VS

MOOD TRIM

TRIM

DOORS

PRECAST CONC.

VSF SOFFIT

DS DOMNSPOUT/ FASCIA

FIBER CEMENT

PANEL

FACE YM YINYL MINDOMS


(PCC)

T INDICATES
TEMPERED GLASS

ISSUANCE

80% CONST. REVIEW OHFA 80% CONST. REVIEW 09/23/2022

JOB NUMBER: WOD267

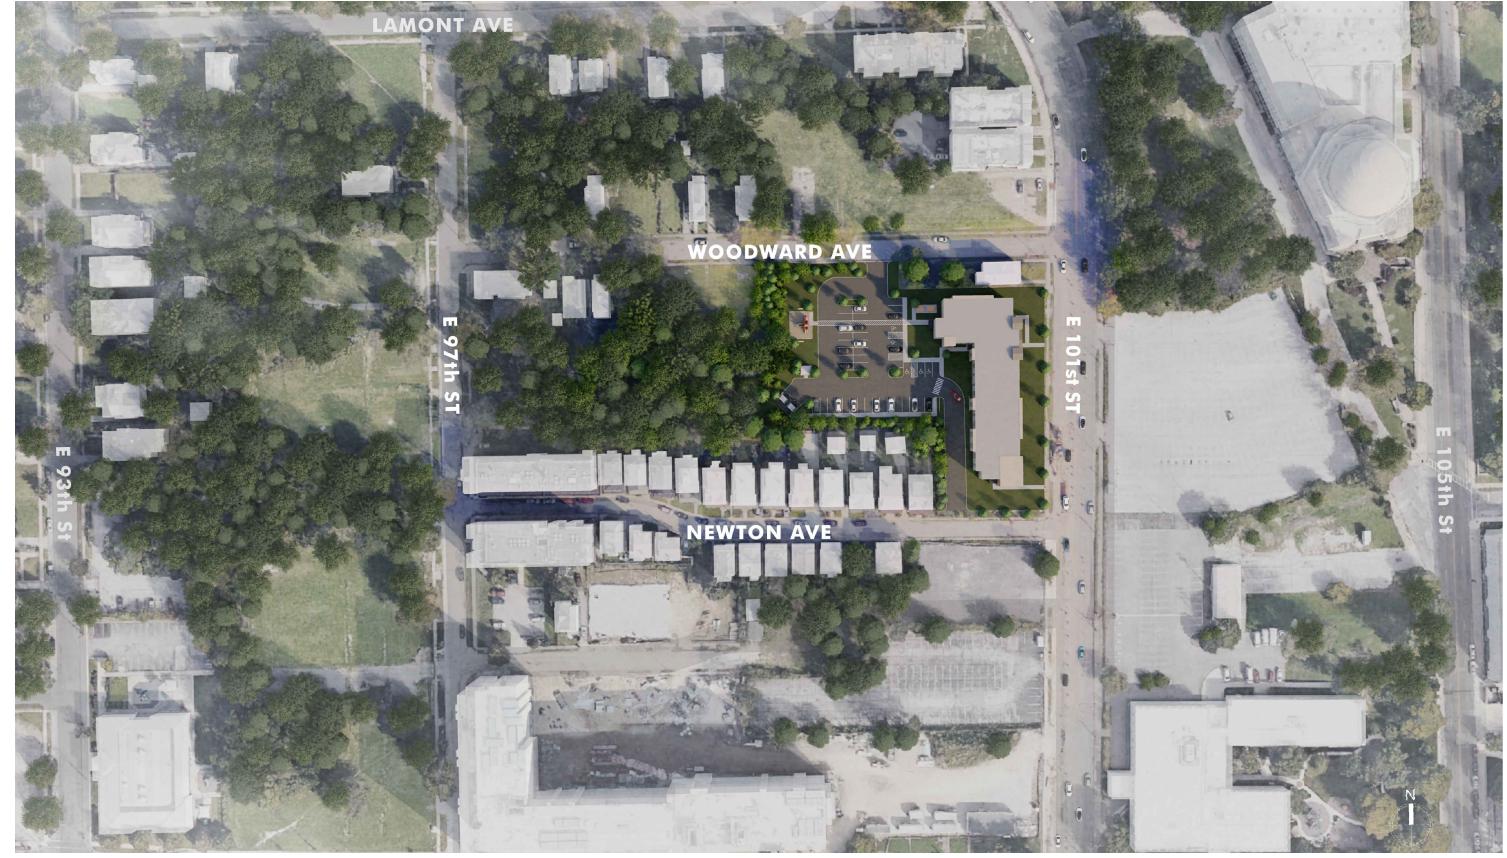



SITE CONTEXT PLAN

PCI DESIGN GROUP, INC.
500 SOUTH FRONT STREET SUITE 975
COLUMBUS, OHIO 43215



PROJECT TYPE:
MULTI-FAMILY **OCCUPANCY** HOUSING

SITE CONTEXT PLAN

01-26-2023

GORDON CROSSING WOODWARD AVE. & EAST 101ST ST. CLEVELAND, OHIO 44106

LANDMARKS APPLICATION

A2.1





RTIST RENDERING PROVIDED BY POD DESIGN

ARCHITECT OF RECORD:

PCI DESIGN GROUP, INC.
500 SOUTH FRONT STREET SUITE 975
COLUMBUS, OHIO 43215



PROJECT TYPE:
MULTI-FAMILY
OCCUPANCY
HOUSING

SHEET TITLE:


SITE PLAN

01-26-2023 DRAWN BY: GORDON CROSSING
WOODWARD AVE. & EAST 101ST ST.
CLEVELAND, OHIO 44106

SERIES:


LANDMARKS APPLICATION

A2.2

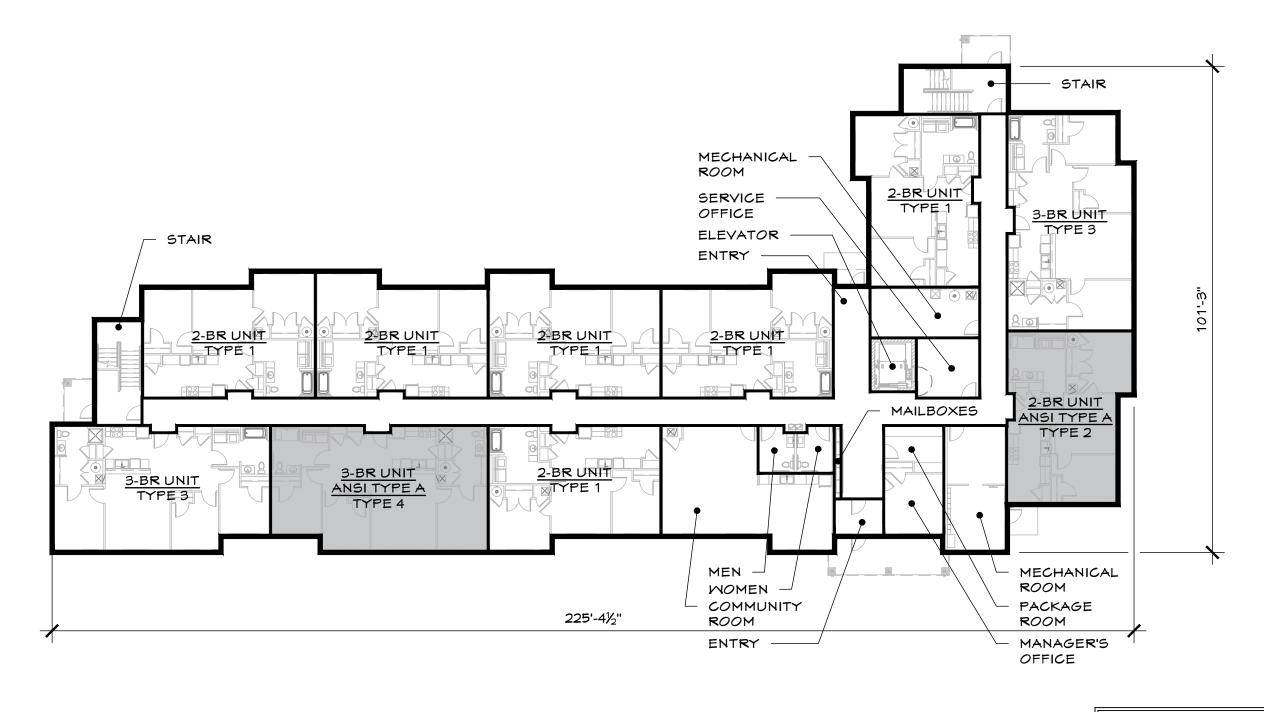



SEE SHEET A1.3 FOR "BUILDING WIDE - TYPICAL NOTES"

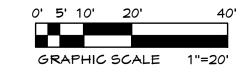

ARCHITECT OF RECORD:

PCI DESIGN GROUP, INC.
500 SOUTH FRONT STREET SUITE 975
COLUMBUS, OHIO 43215



MULTI-FAMILY OCCUPANCY HOUSING


SHEET TITLE: FIRST FLOOR PLAN

01-26-2023 DRAWN BY:

GORDON CROSSING WOODWARD AVE. & EAST 101ST ST. CLEVELAND, OHIO 44106

LANDMARKS **APPLICATION**

A3.1

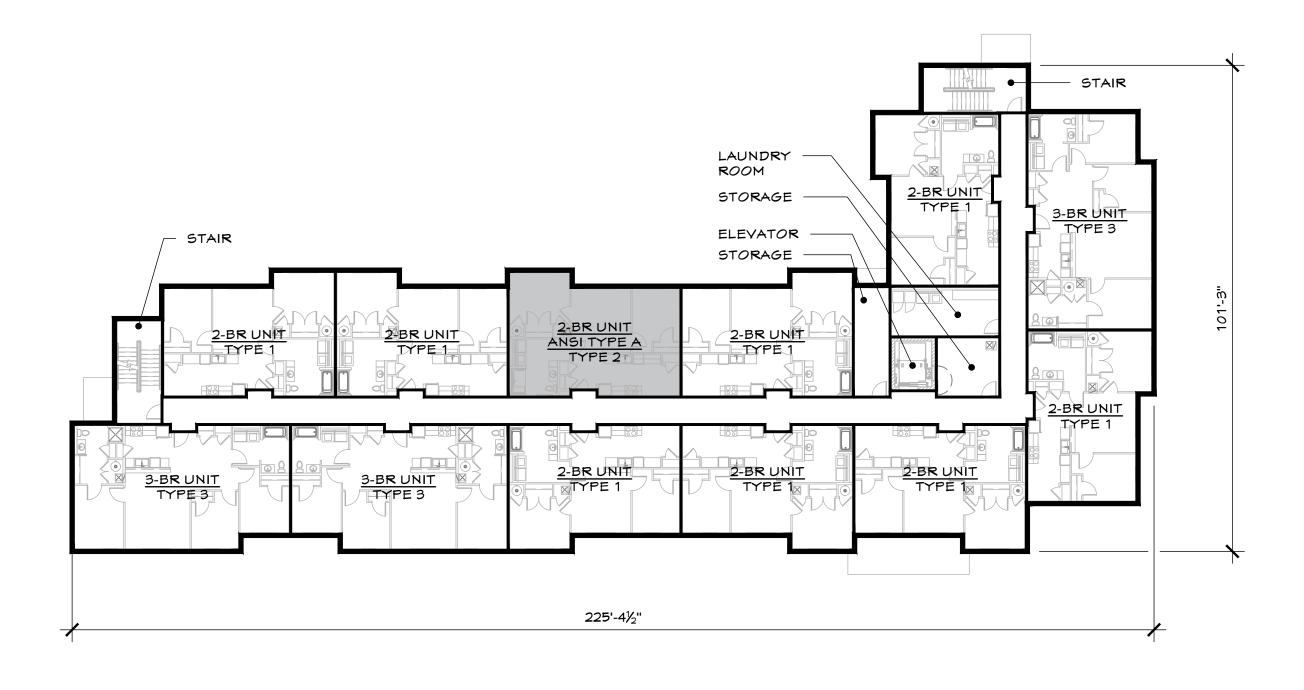



SEE SHEET A1.3 FOR "BUILDING WIDE - TYPICAL NOTES".



ARCHITECT OF RECORD:

PCI DESIGN GROUP, INC.
500 SOUTH FRONT STREET SUITE 975
COLUMBUS, OHIO 43215




MULTI-FAMILY OCCUPANCY HOUSING

SECOND FLOOR PLAN

01-26-2023 DRAWN BY: GORDON CROSSING
WOODWARD AVE. & EAST 101ST ST.
CLEVELAND, OHIO 44106


LANDMARKS APPLICATION

ARKS ATION A3.2

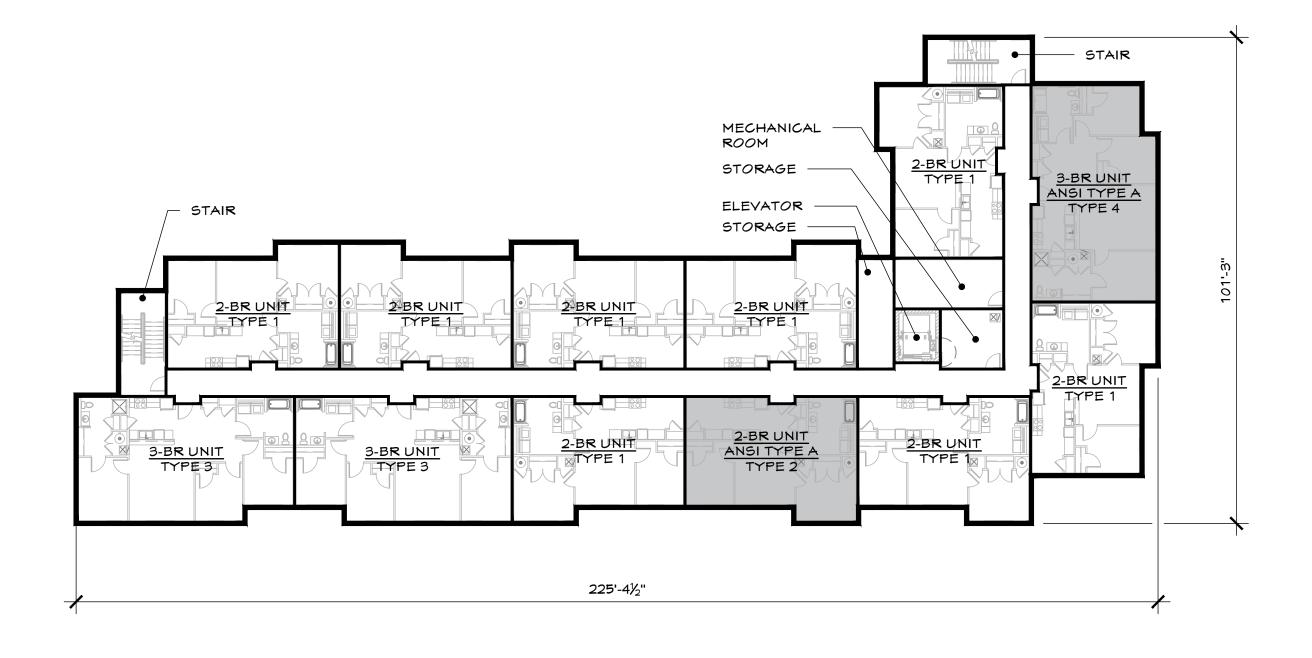



SEE SHEET A1.3 FOR
"BUILDING WIDE - TYPICAL
NOTES".

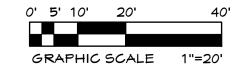

ARCHITECT OF RECORD:

PCI DESIGN GROUP, INC.
500 SOUTH FRONT STREET SUITE 975
COLUMBUS, OHIO 43215



PROJECT TYPE:

MULTI-FAMILY

OCCUPANCY

HOUSING


THIRD FLOOR PLAN

SHEET TITLE:

01-26-2023 DRAWN BY: GORDON CROSSING
WOODWARD AVE. & EAST 101ST ST.
CLEVELAND, OHIO 44106

LANDMARKS APPLICATION

A3.3

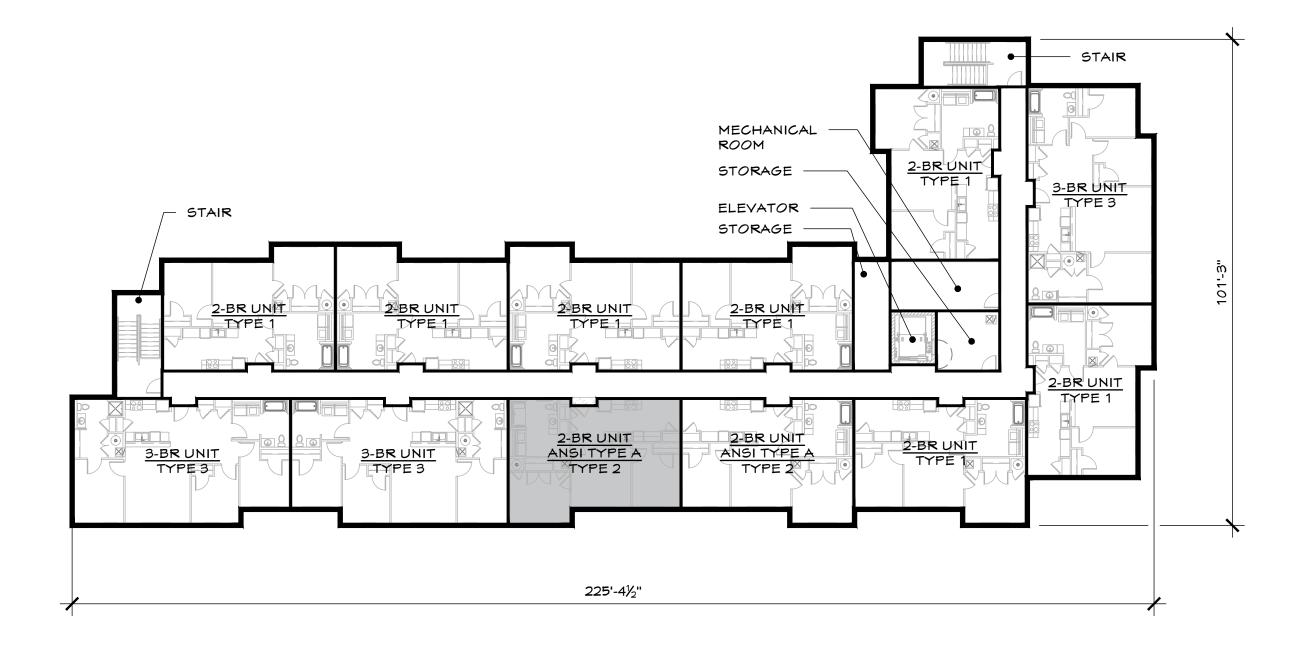



SEE SHEET A1.3 FOR "BUILDING WIDE - TYPICAL NOTES".



ARCHITECT OF RECORD:

PCI DESIGN GROUP, INC. 500 SOUTH FRONT STREET SUITE 975 COLUMBUS, OHIO 43215



MULTI-FAMILY OCCUPANCY HOUSING

FOURTH FLOOR PLAN


SHEET TITLE:

01-26-2023 DRAWN BY:

GORDON CROSSING WOODWARD AVE. & EAST 101ST ST. CLEVELAND, OHIO 44106

LANDMARKS **APPLICATION**


A3.4

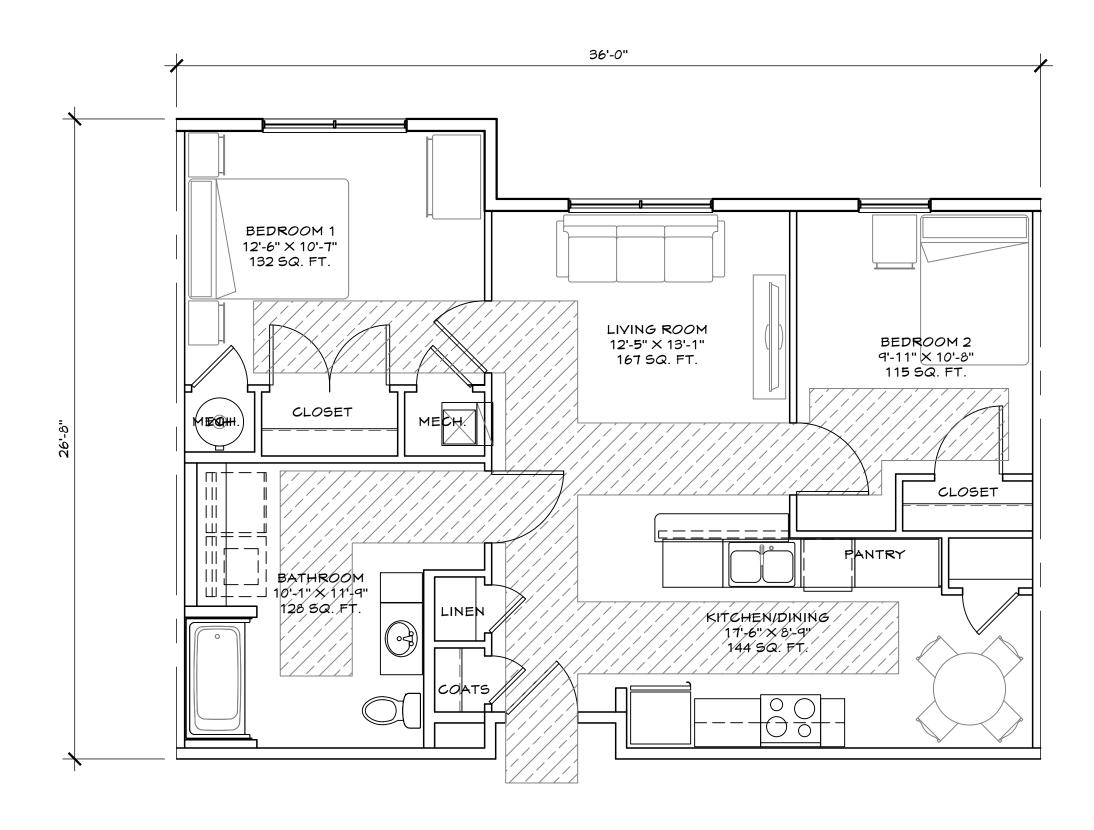





SEE SHEET A1.3 FOR "UNIT AMENITIES - TYPICAL NOTES" AND "ACCESSIBLE DESIGN" AND "UNIVERSAL DESIGN TYPICAL NOTES."

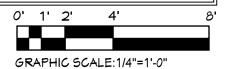

ARCHITECT OF RECORD:

PCI DESIGN GROUP, INC.
500 SOUTH FRONT STREET SUITE 975
COLUMBUS, OHIO 43215




MULTI-FAMILY
OCCUPANCY
HOUSING

2 BEDRM. UNIT TYPE 1 ANSI TYPE B 01-26-2023 DRAWN BY: GORDON CROSSING
WOODWARD AVE. & EAST 101ST ST.
CLEVELAND, OHIO 44106

LANDMARKS


A4.1

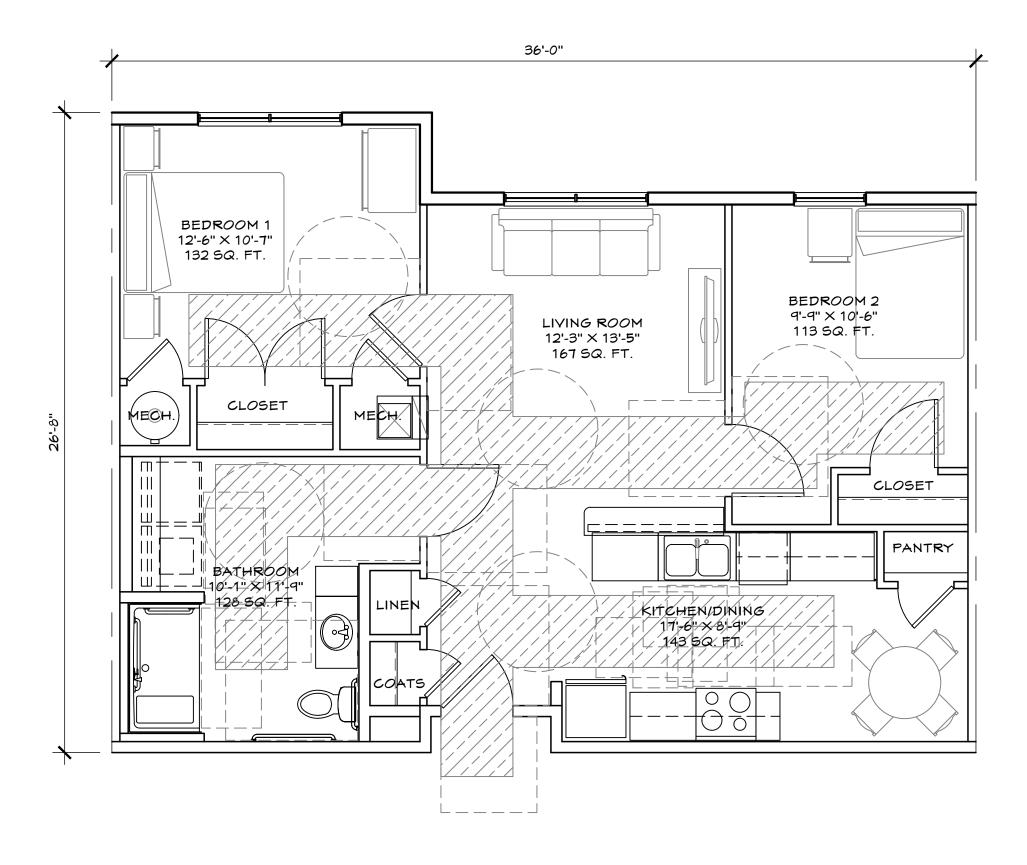





SEE SHEET A1.3 FOR "UNIT AMENITIES - TYPICAL NOTES" AND "ACCESSIBLE DESIGN" AND "UNIVERSAL DESIGN TYPICAL NOTES."

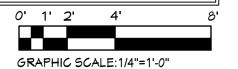

ARCHITECT OF RECORD:

PCI DESIGN GROUP, INC.
500 SOUTH FRONT STREET SUITE 975
COLUMBUS, OHIO 43215




MULTI-FAMILY OCCUPANCY HOUSING

2 BEDRM. UNIT TYPE 2 ANSI TYPE A - ACCESS. 01-26-2023

GORDON CROSSING WOODWARD AVE. & EAST 101ST ST. CLEVELAND, OHIO 44106


LANDMARKS

A4.2 **APPLICATION**

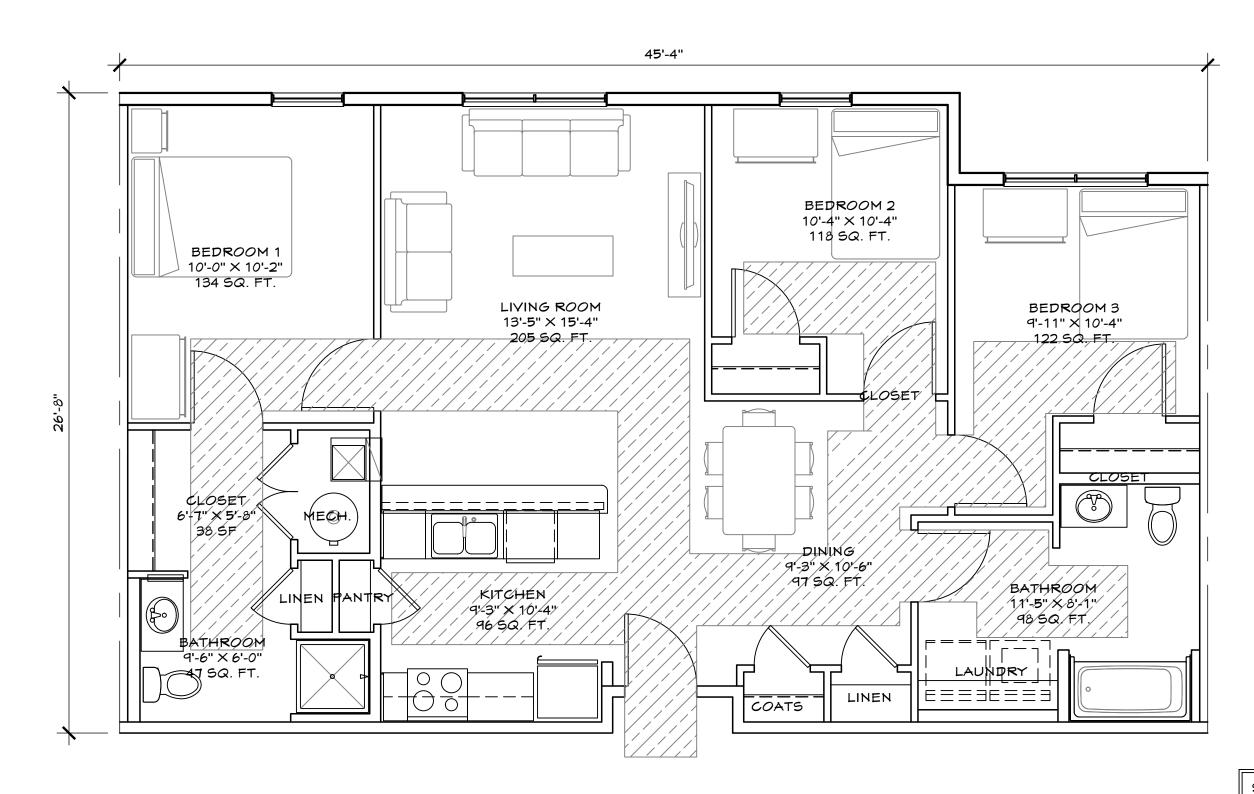



SEE SHEET A1.3 FOR "UNIT AMENITIES - TYPICAL NOTES" AND "ACCESSIBLE DESIGN" AND "UNIVERSAL DESIGN TYPICAL NOTES."

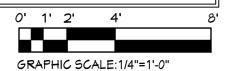

FLOOR PLAN GROSS SQUARE FOOTAGE = 1,167 SF NET SQUARE FOOTAGE = 1,101 SF

ARCHITECT OF RECORD:

PCI DESIGN GROUP, INC. 500 SOUTH FRONT STREET SUITE 975 COLUMBUS, OHIO 43215



MULTI-FAMILY OCCUPANCY HOUSING


3 BEDRM. UNIT TYPE 3 **ANSI TYPE B**

01-26-2023 DRAWN BY:

GORDON CROSSING WOODWARD AVE. & EAST 101ST ST. CLEVELAND, OHIO 44106

LANDMARKS


A4.3 **APPLICATION**

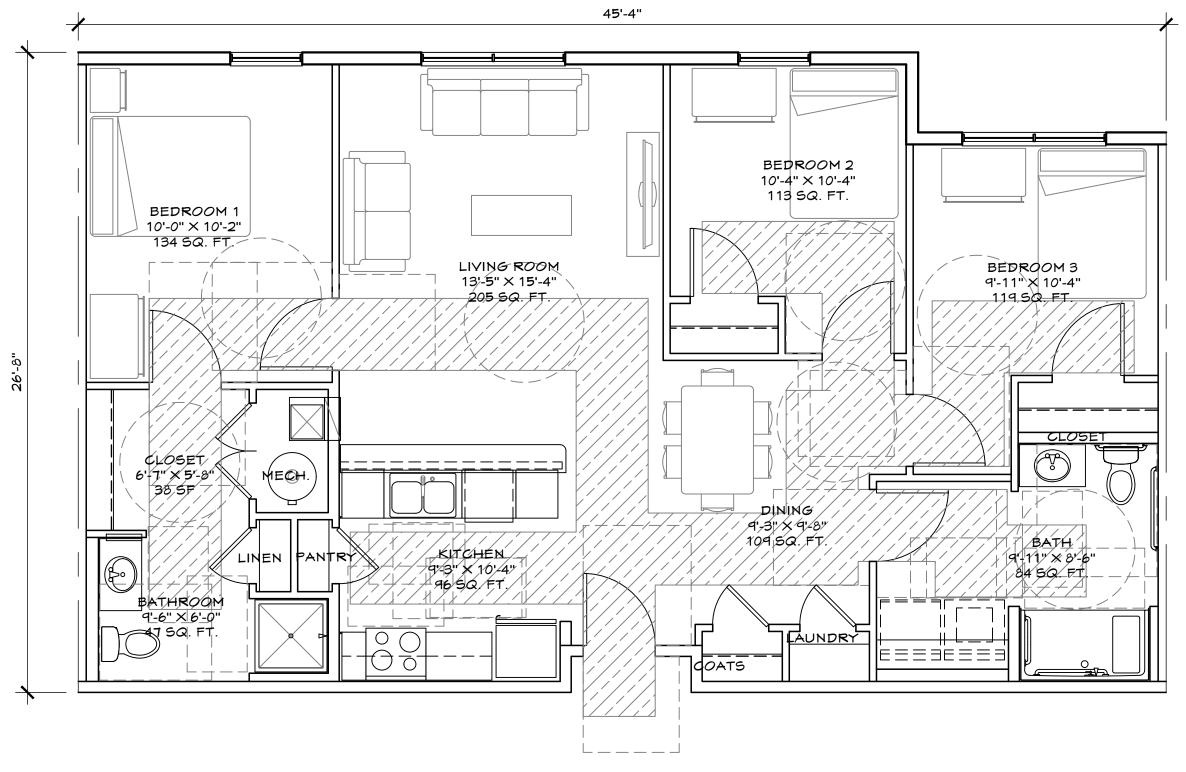



ACCESSIBLE ROUTE

SEE SHEET A1.3 FOR "UNIT AMENITIES - TYPICAL NOTES" AND "ACCESSIBLE DESIGN" AND "UNIVERSAL DESIGN TYPICAL NOTES."

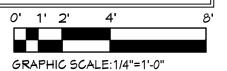

FLOOR PLAN

GROSS SQUARE FOOTAGE = 1,167 SF NET SQUARE FOOTAGE = 1,101 SF

ARCHITECT OF RECORD:

PCI DESIGN GROUP, INC. 500 SOUTH FRONT STREET SUITE 975 COLUMBUS, OHIO 43215



MULTI-FAMILY OCCUPANCY HOUSING

3 BEDRM. UNIT TYPE 4 ANSI TYPE A - ACCESS. 01-26-2023

GORDON CROSSING WOODWARD AVE. & EAST 101ST ST. CLEVELAND, OHIO 44106


LANDMARKS **APPLICATION**


A4.4




OVERALL ELEVATION

SCALE: 1" = 20'-0"

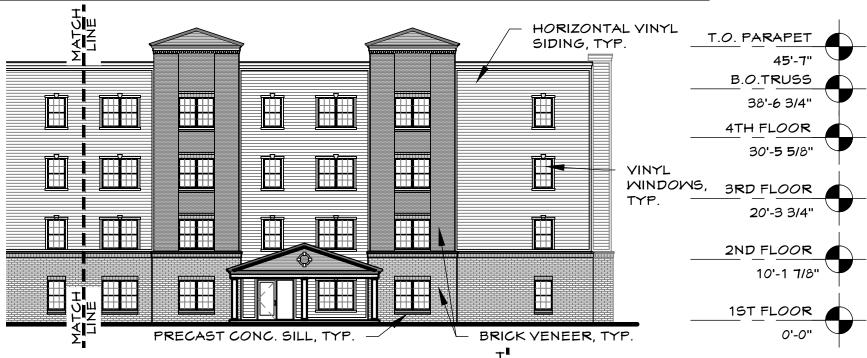

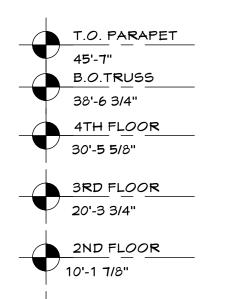

1ST FLOOR

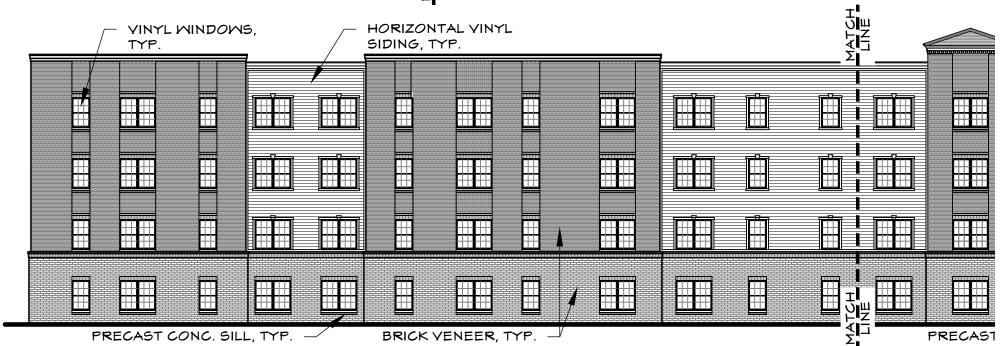

SEE SHEET A1.3 FOR "EXTERIOR MATERIALS TYPICAL NOTES".

ARCHITECT OF RECO

PCI DESIGN GROUP, INC.
500 SOUTH FRONT STREET SUITE 975
COLUMBUS, OHIO 43215


0'-0"

DESIGN GROUP MULTI-FAMILY OCCUPANCY HOUSING

E. 101ST STREET EXTERIOR ELEVATION

01-26-2023 DRAWN BY: GORDON CROSSING WOODWARD AVE. & EAST 101ST ST. CLEVELAND, OHIO 44106


LANDMARKS APPLICATION

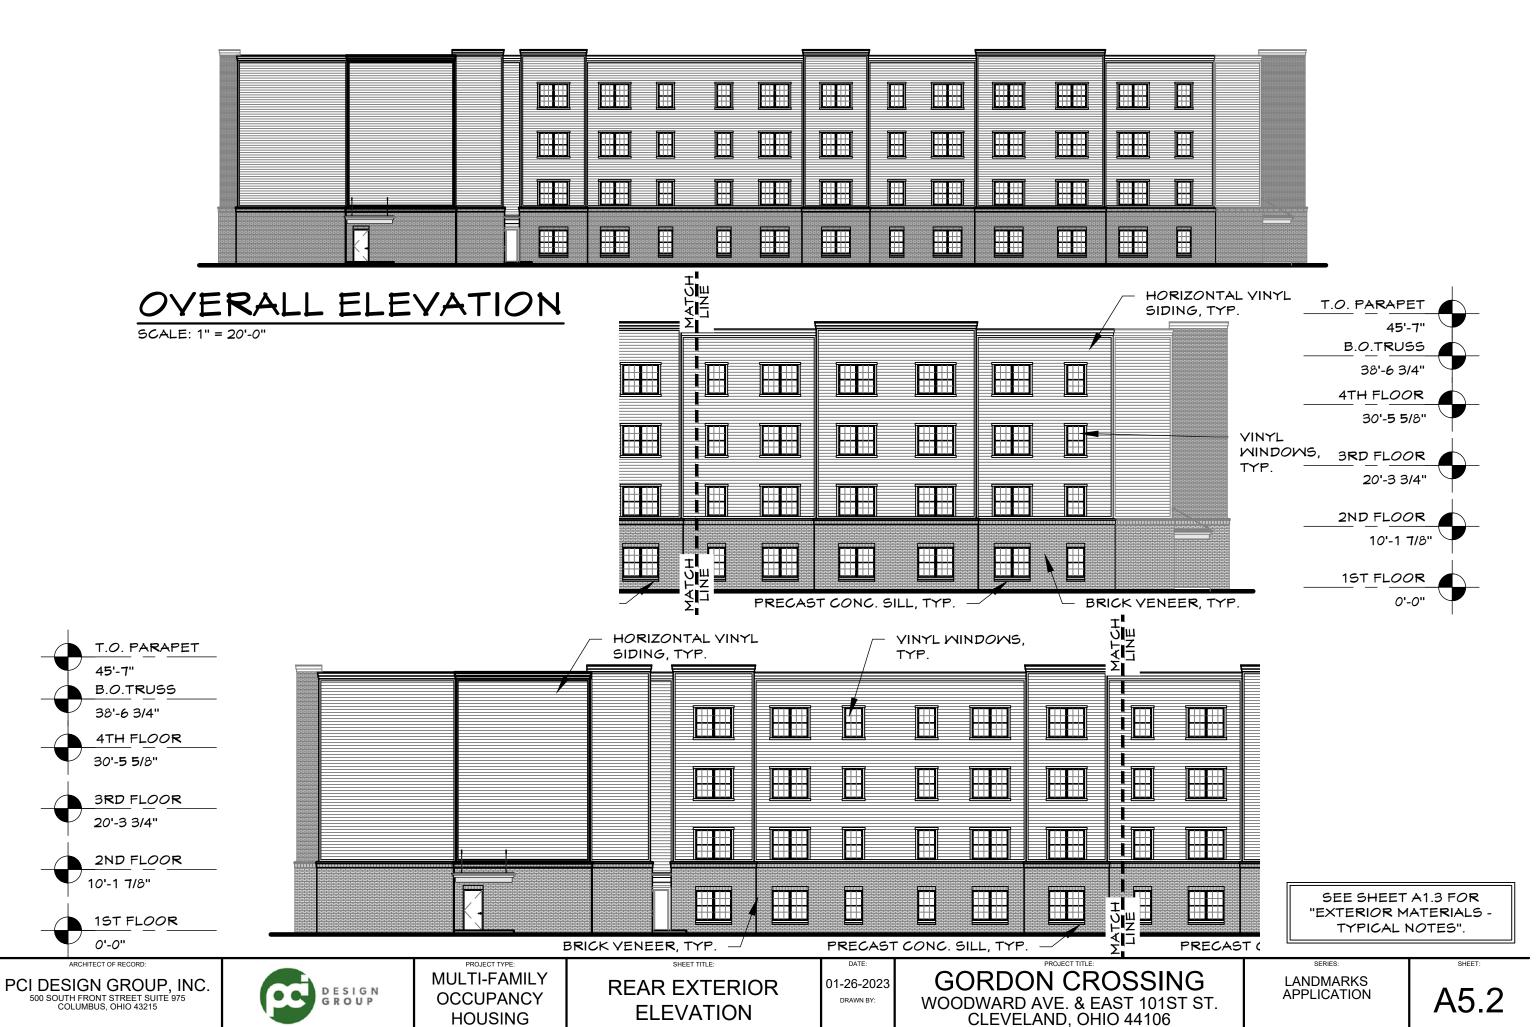


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0'-0"

45'-7"

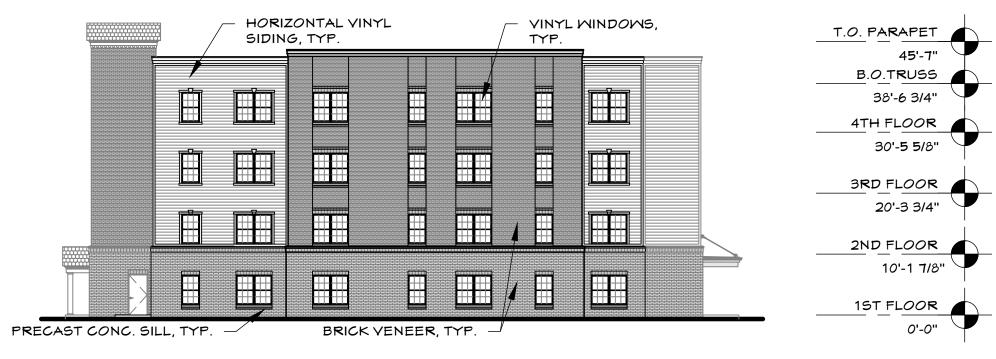

B MOODWARD AVE. ELEVATION



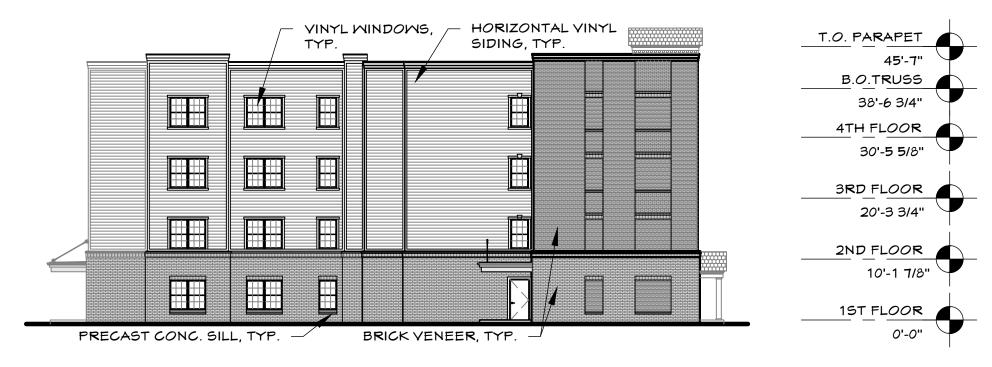

NEMTON AVE. ELEVATION

SEE SHEET A1.3 FOR "EXTERIOR MATERIALS - TYPICAL NOTES".

ARCHITECT OF RECORD:

PCI DESIGN GROUP, INC.
500 SOUTH FRONT STREET SUITE 975
COLUMBUS, OHIO 43215



PROJECT TYPE:

MULTI-FAMILY

OCCUPANCY

HOUSING

IILY CY G E

EXTERIOR ELEVATIONS

01-26-2023 DRAWN BY: GORDON CROSSING
WOODWARD AVE. & EAST 101ST ST.
CLEVELAND, OHIO 44106

LANDMARKS APPLICATION





EXTERIOR ELEVATION

PCI DESIGN GROUP, INC.
500 SOUTH FRONT STREET SUITE 975
COLUMBUS, OHIO 43215



MULTI-FAMILY OCCUPANCY HOUSING


EXTERIOR ELEVATIONS 01-26-2023 **RENDERED**

DRAWN BY:


GORDON CROSSING WOODWARD AVE. & EAST 101ST ST. CLEVELAND, OHIO 44106

LANDMARKS APPLICATION

GORDON CROSSING EXTERIOR FINISHES

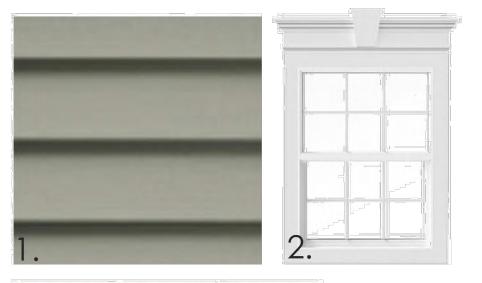




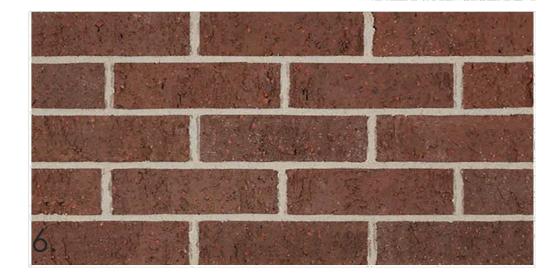



- 2. Vinyl Windows with Keystone Accent
- 3. Rowlock Coarse Belden 481-483 Smooth
- 4. Sill and Cast Stone Cap Reading Rock Ivory
- 5. Dentil Accent
- 6. Facebrick Belden 830 Dart-Tex
- 7. Dark Bronze Store Front
- 8. Dark Bronze Cantilever Awning

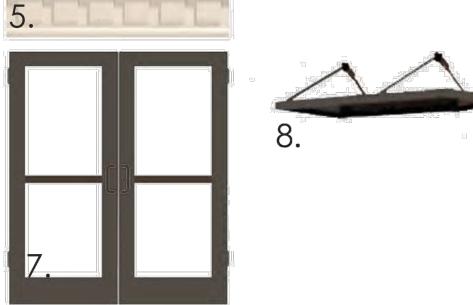





NTS

ARCHITECT OF RECORD.

PCI DESIGN GROUP, INC.
500 SOUTH FRONT STREET SUITE 975
COLUMBUS, OHIO 43215



PROJECT TYPE:
MULTI-FAMILY
OCCUPANCY
HOUSING

EXTERIOR PERSPECTIVE

01-26-2023 DRAWN BY: GORDON CROSSING
WOODWARD AVE. & EAST 101ST ST.
CLEVELAND, OHIO 44106

SERIES:

LANDMARKS APPLICATION





PCI DESIGN GROUP, INC.
500 SOUTH FRONT STREET SUITE 975
COLUMBUS, OHIO 43215



PROJECT TYPE:
MULTI-FAMILY **OCCUPANCY** HOUSING

EXTERIOR PERSPECTIVE 01-26-2023

GORDON CROSSING WOODWARD AVE. & EAST 101ST ST. CLEVELAND, OHIO 44106

LANDMARKS APPLICATION





PCI DESIGN GROUP, INC.
500 SOUTH FRONT STREET SUITE 975
COLUMBUS, OHIO 43215



PROJECT TYPE:
MULTI-FAMILY OCCUPANCY HOUSING

AERIAL PERSPECTIVE

01-26-2023

GORDON CROSSING
WOODWARD AVE. & EAST 101ST ST.
CLEVELAND, OHIO 44106

LANDMARKS APPLICATION





PCI DESIGN GROUP, INC.
500 SOUTH FRONT STREET SUITE 975
COLUMBUS, OHIO 43215




PROJECT TYPE:
MULTI-FAMILY OCCUPANCY HOUSING

AERIAL PERSPECTIVE

01-26-2023

GORDON CROSSING
WOODWARD AVE. & EAST 101ST ST.
CLEVELAND, OHIO 44106

LANDMARKS APPLICATION

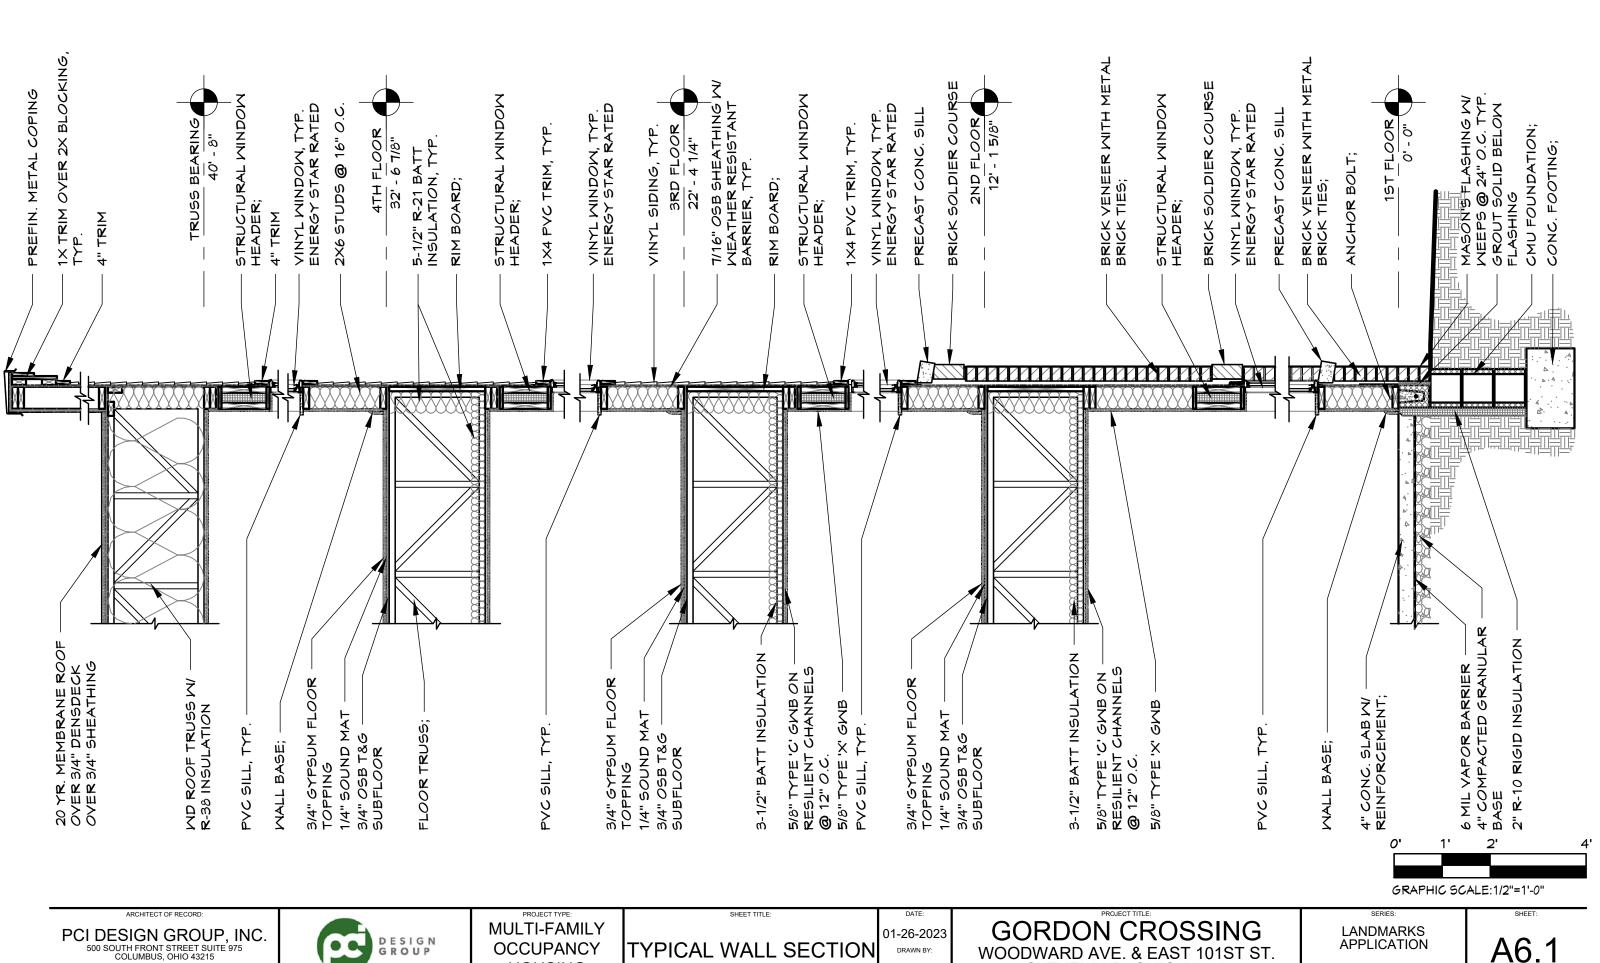

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D E S I G N G R O U P

OCCUPANCY HOUSING

TYPICAL WALL SECTION

01-26-2023

WOODWARD AVE. & EAST 101ST ST. CLEVELAND, OHIO 44106

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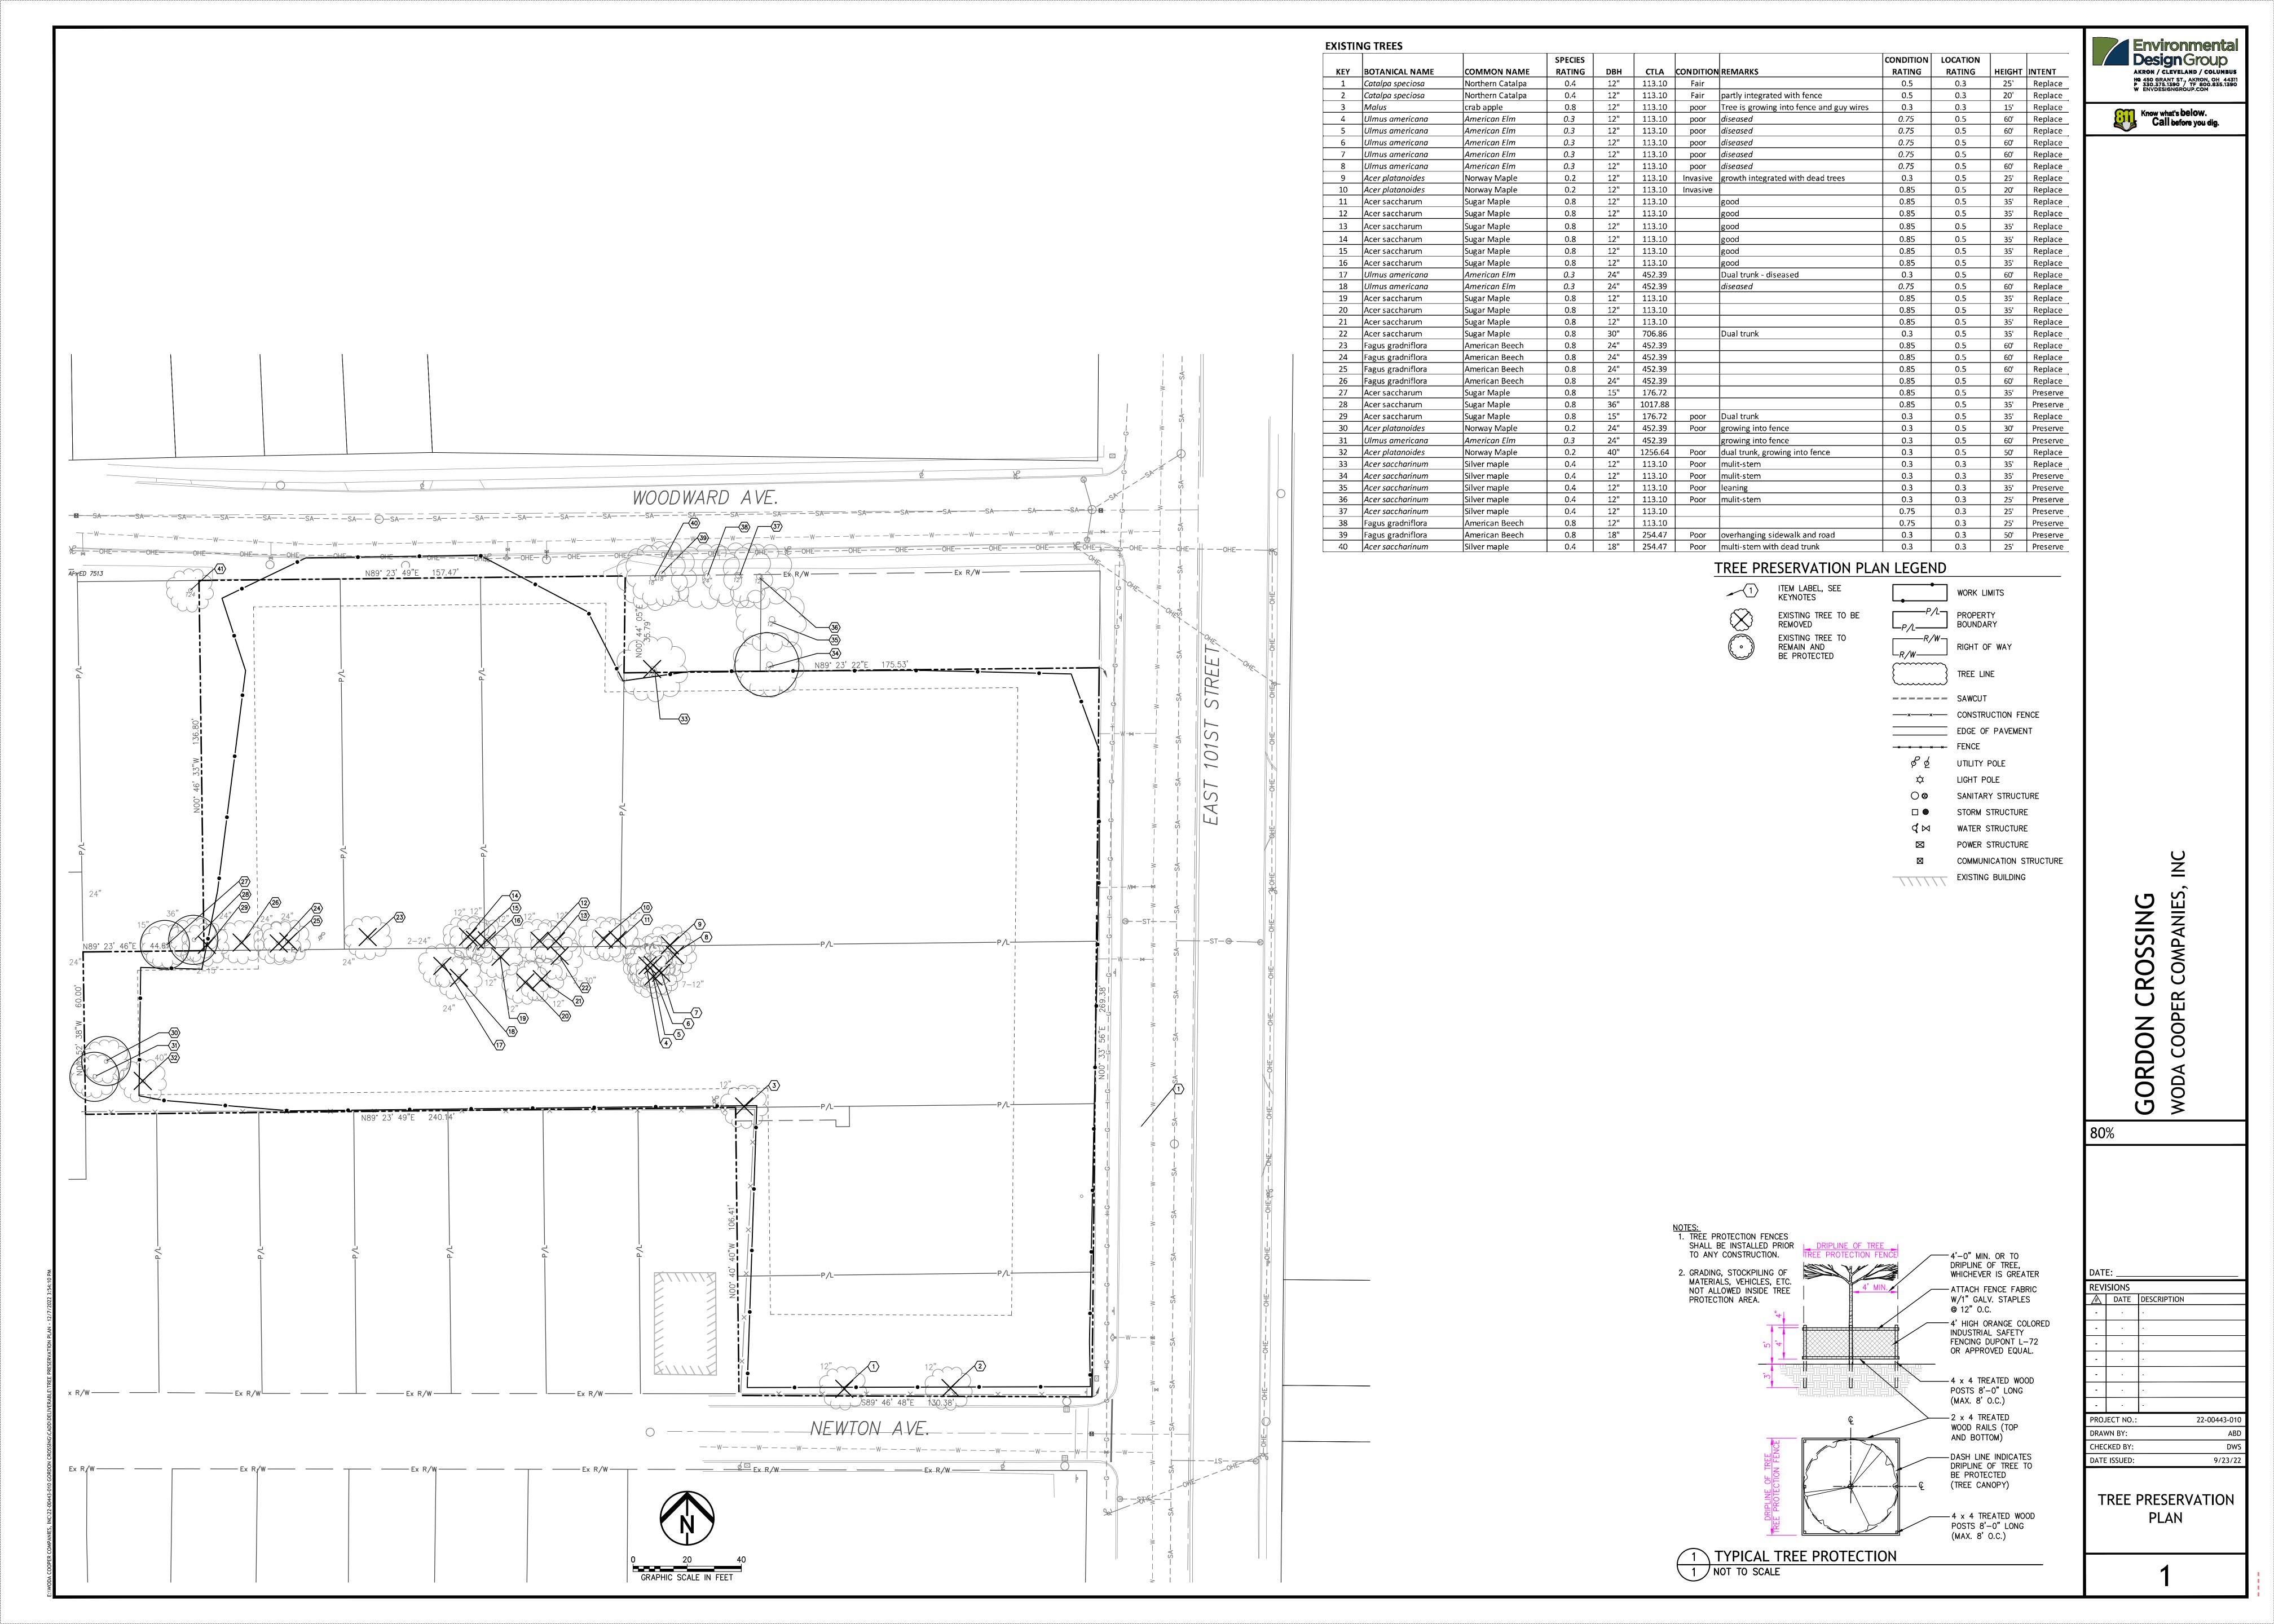
A6.1



500 South Front St 10th Floor Columbus, Ohio 43215

Tree Preservation Plan

The Tree Preservation Plan included in this application is the same one that was provided to the Euclid Corridor Design Review in the Conceptual Review Meeting. The feedback received at that meeting, which meant a major redesign of the site, was incorporated into this application. The building has now been moved to maximize frontage along East 101^{st} Street. The site includes ingress off of Woodward Avenue and egress to Newton Avenue. In addition, a landscape buffer will be included between the site and the single-family homes in the Newton Avenue historic district in order to provide a smooth transition and act as a bookend to Newton Avenue. Please note that the Tree Preservation Plan reflects the old version of the site plan prior to the redesign and is included for reference purposes only. The Tree Preservation Plan is being updated to reflect the new redesign and will be provided once completed.



Design Review



Euclid Corridor Design Review Case Detail Report

City of Cleveland known

Project Information

Euclid Corridor CASE # EC 2022-038

Project Name: Gordon Crossing

Address: E 101st & Woodward Ave,
Company: Woda Cooper Companies
Architect/Contractor: PCI Design Group Inc.

General Description:

Notes:

ACTIONS/APPROVALS/DISAPPROVALS

Action		
Action Date:		
Committee:	Staff	
Action Type:	Initial Plan Submission	
Notes:		

Action	
Action Date:	
Committee:	Local Design Review Committee
Action Type:	No Action Taken
Conditions:	Committee requested additional information Study how the building can be better sited on the property (move it north so that parking is in the rear.
Notes:	

Staff Report



Design Review Committee Appointments



Design Review Committee Appointments

CLEVELAND OF COMPANY O

January 26, 2023

Historic West Cleveland Historic District

1. Claire Markwardt Bank

Meeting Minute Approvals



Meeting Minutes Approval



January 26, 2023

December 22, 2022

August 11, 2022

July 14, 2022

November 14, 2013

Administrative Reports



Adjournment



